

45 MCLAREN PTY LTD



Preliminary Site Investigation

45 McLaren Street, North Sydney NSW

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Executive Summary

Background

45 McLaren Pty Ltd engaged El Australia (El) to conduct a Preliminary Site Investigation (PSI) of the land parcel with street address 45 McLaren Street, North Sydney NSW ('the site'). This investigation was required to appraise the environmental condition of the site, in support of a Planning Proposal (PP) to North Sydney Council for the construction of a sixteen (16) storey, mixed-use, commercial / residential (apartment) building, overlying three levels of commercial / retail space and four levels of basement car parking facilities. Bulk excavation to a maximum depth of RL 48.0m AHD was required.

Objective

The primary objective of this PSI was to provide a qualitative assessment of the environmental condition of the site, by appraising the potential for contamination on the basis of field observations, historical land uses and anecdotal and documentary evidence.

Findings

The key findings of this PSI were as follows:

- The history review indicated that site use had been residential since the early 1900s, at least. Initially, the site was comprised of three residential dwellings (houses). In (or by) 1970, the land was cleared, then redeveloped into a multi-level, residential apartment building (which remained to the present time).
- Surrounding land uses were predominantly low to medium density residential (i.e. on-going since the early 1900s, at least).
- There was no evidence that an industrial activity of significance had ever occurred, either on-site, or in the surrounding area.
- The site and neighbouring properties (≤250m radius) were free of statutory notices and licensing agreements issued under the Contaminated Land Management Act 1997 and Protection of the Environment Operations Act 1997. The site was not included on the List of NSW Contaminated Sites Notified to the EPA.
- Visual evidence of gross contamination, including fragments of fibre cement sheeting (FCS), was not observed on any part of the site. No suspicious odour was detected during the site inspection.
- There was no evidence that an underground storage tank (UST) was present on the site.
 No above-ground storage tank (AST) was identified.
- The potential for acid sulfate soils (ASS) to be present on the site was extremely low.
- The conceptual site model (CSM) established that the potential for site contamination was low.

Conclusion

Based on the findings of this PSI and with due consideration of El's Statement of Limitations (**Section 7**), it was concluded that the site is not likely to be contaminated. Provided that appropriate waste soil classification and disposal is undertaken following building demolition, El believes that the site will be suitable for the proposed development, in accordance with *State Environmental Planning Policy* 55 (SEPP 55) - *Remediation of Land*.



1. Introduction

1.1 Background and Purpose

45 McLaren Pty Ltd engaged El Australia (El) to conduct a Preliminary Site Investigation (PSI) of the land parcel with street address 45 McLaren Street, North Sydney NSW (herein referred to as the 'the site').

The site is located 3.6km north of the Sydney Central Business District (CBD), within the Local Government Area (LGA) of the North Sydney Council (**Appendix A**, **Figure 1**). It comprises a multistorey, residential apartment building, with a total area of 1,792m² (**Appendix B**).

It was understood that this investigation was required to appraise the environmental condition of the site, in support of a Planning Proposal (PP) to North Sydney Council.

1.2 Proposed Development

Based on the updated Architectural Plans prepared by BatesSmart (**Appendix B**), the site is designated for the construction of a sixteen (16) storey, mixed-use, commercial / residential (apartment) building, overlying three levels of commercial / retail space and four levels of basement car parking facilities. Bulk excavation to a maximum depth of RL 48.0m AHD was required.

1.3 Regulatory Framework

The following regulatory framework and guidelines were considered during this PSI:

- Contaminated Land Management Act 1997 (the CLM Act 1997);
- Protection of the Environment Operations Act 1997 (the POEO Act 1997);
- Environmental Planning and Assessment Act 1979 (the EP&A Act 1997) and associated State Environmental Planning Policies (SEPPs); in particular Ministerial Direction 2.6 – Remediation of Contaminated Land;
- North Sydney Local Environmental Plan 2013;
- NEPC (2013) Schedule B(2) Guideline on Site Characterisation;
- EPA (2017) Guidelines for the NSW Site Auditor Scheme; and
- EPA (2020) Consultants Reporting on Contaminated Land: Contaminated Land Guidelines

1.4 Project Objective

The primary objective of this PSI was to provide a qualitative assessment of the environmental condition of the site, by appraising the potential for site contamination on the basis of field observations, historical land uses and anecdotal and documentary evidence.

A secondary objective was to make recommendations for further investigation of the site, should the potential for contamination be confirmed.

1.5 Scope of Works

In order to achieve the primary objective, the following scope of works was completed:

- Review of relevant (hydro)geological and soil landscape maps for the project area;
- A search of groundwater bore records within close vicinity to the site;



- A site walkover inspection;
- Review of site operational history, based on land titles records, aerial photographs and property files archived by North Sydney Council;
- Searches of public registers maintained by the New South Wales Environment Protection Authority (EPA) for statutory notices and licensing agreements issued under the Contaminated Land Management Act 1997 and Protection of the Environment Operations Act 1997;
- A search of the List of NSW Contaminated Sites Notified to the EPA; and
- Reporting.

This PSI report was completed with reference to the EPA (2020) *Consultants Reporting on Contaminated Land: Contaminated Land Guidelines*. It documents the investigation works, with discussion of the findings in regards to human health, the environment and the aesthetic condition of the land. It concludes with statements concerning the potential for contamination to exist on the land and the site's suitability for the proposed (mixed commercial / residential) land use.



2. Site Description

2.1 Property Identification, Location and Physical Setting

The site identification details and associated information are presented in **Table 2-1**, while the site locality is shown in **Appendix A**, **Figure 1**.

Table 2-1 Site Identification, Location and Zoning

	,
Attribute	Description
Street Address	45 McLaren Street, North Sydney NSW 2060.
Location Description	3.6km north of the Sydney CBD, bound by Walker Street to the east, McLaren Street to the north, Harnett Street to the west and residential properties to the south.
	Mixed commercial and residential surroundings.
Site Coordinates	Northern corner of site (datum GDA2020-MGA56):
	Easting: 334317.661;
	Northing: 6254675.554.
	(Source: http://maps.six.nsw.gov.au)
Site Area	1,792m²
	(Sources: Appendix B)
Lot and Deposited Plan (DP)	SP14598
State Survey Marks	One Permanent Survey Mark (PM) is in close proximity to the site, that being PM35733 (north east of site, on corner of McLaren Street and Walker Street).
	(Source: http://maps.six.nsw.gov.au)
Local Government Authority	North Sydney Council
Parish	Willoughby
County	Cumberland
Current Zoning	R4 - High Density Residential
	(North Sydney LEP 2013)

2.2 Surrounding Land Use

The site was situated within an area of mixed land uses, predominantly high density residential and commercial, with business corridors following Warringah Freeway and the Pacific Highway (**Table 2-2**).

Table 2-2 Surrounding Land Uses

	9	
Direction	Land Use Description	Sensitive Receptors (distance from site)
North	Residential and commercial properties	School (Junior, Middle and Senior)
East	Residential properties	Local residents (approximately 20m)
South	Residential and commercial properties	Local residents (next door)
West	Residential and commercial properties	Local residents (approximately 20m)



2.3 Regional Setting

Regional topography, (hydro) geology and soil landscape information is presented in Table 2-3.

Table 2-3 Regional Setting Information

Attribute	Description
Topography	The site is located within a relatively gently undulating area. The land displays a moderate slope to the south, along Waker Street.
	The regional topography is described as undulating to rolling low hills with local relief 20-80m and sloped of 10-25%. Side slopes with narrow to wide outcropping sandstone rock benches (10-100m), often forming broken scarps of <5m (Chapman and Murphy, 1989).
Site Drainage	Site drainage is likely to be consistent with the general slope of the site. Stormwater is expeceted to be collected by pit and pipe drainage, discharging into the municipal stormwater system.
Regional Geology	According to the Department of Mineral Resources Sydney 1:100,000 Geological Series Sheet 9130 (DMR, 1983), the site is underlain by Hawkesbury Sandstone (Rh). Hawkesbury Sandstone consists of medium to coarse-grained quartz sandstone, very minor shale and laminite lenses.
Soil Landscape	The Soil Conservation Service of NSW Soil Landscapes of the Sydney 1:100,000 Sheet 9130 (Chapman and Murphy, 1989) indicates that the site is situated within a Gymea (gy) landscape. The Gymea landscape is characterised by undulating to rolling rises and low hills on Hawkesbury Sandstone, with shallow to moderately deep (30-100cm) soils, typically consisting of loose, coarse sandy loams and clayey sands. Rock outcrops are common.
Acid Sulfate Soil (ASS) Risk	The North Sydney LEP 2013 Acid Sulfate Soil Map (Sheet_010) has no defined data for the subject area. With reference to the Parramatta-Prospect Acid Sulfate Soil Risk Map (1:25,000 scale; Murphy, 1997), the subject land lies within the class description of 'No Known Occurrence'. In such cases, ASS are not known or expected to occur and "land management activities are not likely to be affected by ASS materials." Based on the regional setting (map) findings, it was considered that the likelihood of ASS being present on the site was low and further ASS assessment was unwarranted.
Nearest Surface Water Feature	Lavender Bay, located approximately 1km south of the site.
Anticipated Groundwater Flow Direction	Groundwater flow is anticipated to follow local topography (i.e. southward to Lavender Bay).

2.4 Groundwater Bore Records and Groundwater Use

An online search for groundwater bores registered with WaterNSW was conducted by EI on 21 April 2020 (Ref. https://realtimedata.waternsw.com.au/water.stm). The search revealed no registered bores within a 500m radius of the site. This indicated that the local groundwater resource was not being (heavily) utilised.

2.5 Site Walkover Inspection

Site observations were recorded during a walkover inspection conducted on 15 July 2020. A summary of these observations is detailed below and photographs taken during the inspection are present in **Appendix C**.

- The site was occupied by a five level, residential apartment building, comprised of brick wall exterior, street facing balconies and a single level basement (for car parking).
- The site had a moderate slope toward the south, consistent with the gradient of Walker Street.



- The concrete slab(s) on grade were observed to be in good condition with some minor crack.
- Multiple garden beds were observed adjacent to the site fencing (i.e. boundaries), with large trees, flowering shrubs and weeds growing directly in the available soils. No visible sign of distress on vegetation was observed.
- Visual evidence of gross contamination, including fragments of fibre cement sheeting (FCS), was not observed on any part of the site.
- No suspicious odour was detected during the site inspection.
- There was no evidence that an underground storage tank (UST) was present on the site. No above-ground storage tank (AST) was identified.
- There was no evidence of the storage of chemicals.
- There were no (stockpiled) waste materials observed on the property.

2.6 Previous Environmental Reports

El was not aware of any previous environmental investigation relating to the site.



3. Site History and Searches

3.1 Land Titles

A historical land titles search was conducted through InfoTrack Pty Ltd on 9 July 2020. Copies of relevant documents resulting from this search are presented in **Appendix D**. A summary of previous and current registered proprietors is provided in **Table 3-1**.

Table 3-1 Summary of Owner History

Date / Period of Acquisition	Registered Proprietor(s) and Occupation(s)
Section (1) as per the Cadastral Record Enquiry (Appendix D)	
22.09.1922 (1922 to 1923)	Agnes Jane Newton (Widow)
15.05.1923 (1923 to 1937)	Ada Elise Lovegrove (Spinster)
25.05.1937 (1937 to 1946)	Ethel Mary Kate Lovegrove (Spinster) Horace Charles Lovegrove (Optician) (Transmission Application not investigated)
01.08.1946 (1946 to 1957)	Ethel Mary Kate Lovegrove (Spinster) Selina Elizabeth Lovegrove (Widow) (Transmission Application not investigated)
18.12.1957 (1957 to 1958)	Ethel Mary Kate Lovegrove (Spinster) John Abbott Palmer (Company Secretary) (Section 94 Application not investigated)
30.05.1958 (1958 to 1958)	John Abbott Palmer (Company Secretary) Arthur Lynton Clowes (Medical Practitioner) Frank Meredith Clowes (Retired) (Transmission Application not investigated)
30.05.1958 (1958 to 1959)	John Abbott Palmer (Company Secretary) Marie Elaine Josephine Jamieson (Spinster) Frank Meredith Clowes (Retired)
Section (2) as per the Cadastral Record Enquiry (Appendix D)	
22.09.1922 (1922 to 1930)	Agnes Jane Newton (Widow) (and her deceased estate)
01.08.1930 (1930 to 1934)	Frank Newton (Clerk)
06.06.1934 (1934 to 1935)	William Daniel Kennedy (Engineer) Edith Kennedy (Married Woman)
15.11.1935 (1935 to 1939)	Robert Duncan Stewart (Retired Civil Servant)
29.08.1939 (1939 to 1947)	Helen Sophia Work (Widow) (and her deceased estate)
16.04.1947 (1947 to 1947)	Paul Frederick Joseph Madden (Accountant)
05.05.1947 (1947 to 1974)	Norbert Sale Madden (Taxi Driver) Kathleen Agnes Madden (Married Woman)



Date / Period of Acquisition	Registered Proprietor(s) and Occupation(s)
06.12.1974 (1974 to 1977)	Norbert Sale Madden (Gardener)
04.03.1977	Paul Frederick Madden (Accountant)
(1977 to 1978)	Peter Baldock (Civil Engineer)
10.01.1978	Kurralta Pty Limited
(1978 to 1980)	Narrana F ty Elimica
Section (3) as per the Cadastral	Record Enquiry (Appendix D)
09.01.1905	Eliza Moore (Married Woman)
(1905 to 1936)	Eliza Moore (Married Worldari)
02.09.1936	Samuel Stewart Moore (Retired Merchant)
(1936 to 1949)	(Transmission Application not investigated)
13.09.1949	Doris McRae (Spinster)
(1949 to 1974)	(Transmission Application not investigated)
17.1.21974	lan Charles Wigney (Wholesaler)
(1974 to 1975)	Tan Chance Wighey (Wholosalor)
04.02.1975	Kurralta Pty Limited
(1975 to 1980)	
Section (4) as per the Cadastra	I Record Enquiry (Appendix D)
22.09.1887	Annie Lehmann (Married Woman)
(1887 to 1919)	Anne Lemmann (Married Worldin)
17.12.1919	Annie Anne Lehmann (Spinster)
(1919 to 1973)	(Transmission Application not investigated)
14.06.1973	Kurralta Pty Limited
(1973 to 1980)	Narrana i iy Emiliou
Common Property Areas	
07.01.1980	Registration date of Strata Plan No. 14598
07.01.1980	# The Proprietors Strata Plan No. 14598

Note 1 # denotes current registered proprietor

3.2 Historical Aerial Photographs

Information relating to past land uses from the available aerial photographs is summarised in **Table 4-2**. The aerial photographs reviewed as part of this DSI were the following:

- **1940:** Department of Finance, Service & Innovation; Historical Imagery https://portal.spatial.nsw.gov.au/portal/apps/webappviewer/index.html
- 1950: Department of Finance, Service & Innovation; Historical Imagery https://portal.spatial.nsw.gov.au/portal/apps/webappviewer/index.html
- **1960:** Department of Finance, Service & Innovation; Historical Imagery https://portal.spatial.nsw.gov.au/portal/apps/webappviewer/index.html
- **1970:** Department of Finance, Service & Innovation; Historical Imagery https://portal.spatial.nsw.gov.au/portal/apps/webappviewer/index.html
- 1980: Department of Finance, Service & Innovation; Historical Imagery https://portal.spatial.nsw.gov.au/portal/apps/webappviewer/index.html



- 1990: Department of Finance, Service & Innovation; Historical Imagery https://portal.spatial.nsw.gov.au/portal/apps/webappviewer/index.html
- 2000: Department of Finance, Service & Innovation; Historical Imagery https://portal.spatial.nsw.gov.au/portal/apps/webappviewer/index.html
- 2016: maps.six.nsw.gov.au.

Table 3-2 Summary of Aerial Photograph History

Photograph	Site Description	Inferred Land Use
1940	The site appears to be comprised of three residential dwellings Surrounding land appears low to medium density residential Large commercial / recreational style lot to the north of McLaren Street.	Residential
1950	The site appears unchanged from previous image Surrounding land appears relatively unchanged Minor alterations appear on commercial / recreational style lot to the north of McLaren Street.	Residential
1960	The site appears unchanged from previous image A multi-storey building has been erected to the west of the site Significant land clearing has taken place to the east of the site	Residential
1970	The site appears to have been cleared Multiple, large scale commercial / high density residential structures erected immediately west of the site Two large commercial / high density residential structures erected immediately north of McLaren Street Significant commercial developments constructed 0.5km south of the site Warringah Freeway has been constructed to the east of the site (as per its present day configuration)	Residential
1980	The site appears to be in present day configuration Commercial / high density residential development continues to the immediate south-west of the site Commercial development continues 0.5km south of the site	Residential
1990	The site appears unchanged from previous image Surrounding land use appears unchanged from previous image	Residential
2000	The site appears unchanged from previous image Surrounding land use appears unchanged from previous image	Residential
2016	The site appears unchanged from previous image Residential lots immediately south of the site have been cleared with high density residential structures erected	Residential

In summary, review of land titles records and historic aerial photography indicated that site use had been residential since the early 1900s, at least.



3.3 Council Information

An application under the *Government Information (Public Access) Act 2009* (GIPA Act 2009) to access records held by North Sydney Council was submitted on 15 July 2020. No response had been received from Council by the time of completing this report.

3.4 EPA Online Records

3.4.1 Record of EPA Notices

An on-line search of the contaminated land public record of EPA notices was conducted 22 July 2020. The contaminated land public record is a searchable database of:

- Orders made under Part 3 of the CLM Act 1997;
- Notices available to the public under Section 58 of the CLM Act 1997;
- Approved voluntary management proposals under the CLM Act 1997 that have not been fully carried out and where the approval of the EPA has not been revoked;
- Site audit statements provided to the EPA under Section 53B of the CLM Act 1997 that relate to significantly contaminated land;
- Where practicable, copies of anything formerly required to be part of the public record; and
- Actions taken by the EPA under Section 35 or 36 of the Environmentally Hazardous Chemicals Act 1985 (EHC Act 1985).

The search confirmed that the site and immediately surrounding lands within close proximity (≤250m) were not subject to any regulatory notices relevant to the above legislations.

3.4.2 List of NSW Contaminated Sites Notified to EPA

A search through the *List of NSW Contaminated Sites Notified to the EPA* under Section 60 of the *CLM Act 1997* was conducted on 22 July 2020. This list is maintained by the EPA and includes properties on which contamination has been identified, but not deemed to be impacted significantly enough to warrant regulation. The site and surrounding lands within close proximity (≤250m) had not been notified as contaminated to the EPA.

3.4.3 POEO Public Register

A search of the *Protection of the Environment Operations Act 1997* public register was conducted on 22 July 2020. The public register contains records relating to environmental protection licences, applications, notices, audits, pollution studies and waste reduction programs. The search confirmed that the site and surrounding lands within close proximity (≤250m) were not subject to any licensing agreements / notices / programs etc. relevant to this legislation.



4. Conceptual Site Model

In accordance with NEPC (2013) Schedule B2 - Guideline on Site Characterisation, El developed a conceptual site model (CSM) that assessed plausible linkages between potential contamination sources, migration pathways and human and environmental receptors. The CSM provides a framework for identifying gaps in the existing site characterisation.

4.1 Rationale

The primary purpose of this PSI was to appraise the potential for contamination to exist on the site. If it was deemed that there was such potential, the environmental and human-health risks associated with contamination were to be evaluated. These risks were defined as the probability that the utility of the site would be diminished by the presence of soil, soil vapour and/or groundwater contamination.

This appraisal did not involve intrusive sampling and laboratory analysis of soils, soil vapours or groundwater. Instead, the potential for contamination was based on a desktop study, collating information from available maps, historical record searches and government-maintained databases, as well as a walkover inspection. Professional judgement was then applied, based on previous experience.

4.2 Summary of Site History

The history review indicated that site use had been residential since the early 1900s, at least. There was no evidence that a commercial / industrial activity of significance had ever occurred on any part of the site.

4.3 Potential Contamination Sources

4.3.1 Overview

The available historical information indicated that the potential for site contamination from previous use of the land was low. If contamination was present, it would have been derived from:

- Imported fill soils of unknown origin and quality, distributed across the paved areas (at least);
- The weathering of exposed building fabrics containing hazardous substances, including potential asbestos-containing materials (ACM), lead-based paints and metallic surfaces;
- Application of pesticides beneath the building footprints and around footings; and
- Leaks from vehicles in parking areas.

The potential for migration of (mobile) contaminants from off-site sources was regarded as very low, due to the surrounding land use being predominantly low to medium density residential (i.e. on-going since the early 1900s, at least). No industrial activities had occurred in the area.

4.3.2 Per and Poly- Fluoroalkyl Substances (PFAS)

EPA (2017) requires that PFAS are considered when assessing land contamination. A desktop survey of PFAS occurrence is provided in Error! Reference source not found.. This survey was based on guidelines from the *PFAS National Environmental Management Plan* (NEMP, 2020), from which a decision could be made as to whether PFAS sampling of soil and groundwater was required.



In this instance, the potential for PFAS to be present on-site was low and subsequently PFAS sampling / analysis of soil and water was unwarranted.

Table 4-1 PFAS Decision Tree

Preliminary Screening	Probability of Occurrence ¹
Has an activity listed in NEMP (2020) ² as being associated with PFAS contamination occurred on-site? If so, list activity.	L
Has an activity listed in NEMP (2020) ² as being associated with PFAS contamination occurred up-gradient or adjacent to the site? If so, list activity.	L
Did fire training involving the use of suppressants occur on-site between 1970 and 2010?	L
Did fire training occur up-gradient or adjacent to the site between 1970 and 2010? ³	L
Have "fuel" fires ever occurred on-site between 1970 and 2010? (e.g. ignition of fuel (solvent, petrol, diesel, kero) tanks?)	L
Have PFAS been used in manufacturing or stored on-site? 4	L
Could PFAS have been imported to the site in fill materials from a site with an activity listed in NEMP (2020)?	L
Could PFAS-contaminated groundwater or run-off have migrated on to the site?	L
Is the site or adjacent sites listed in the NSW EPA PFAS Investigation Program? 5	L
If the probability is medium or high in any of the rows, does the site analytical suite need to be optimised to include preliminary sampling and testing for PFAS in soil (including ASLP testing) and waters?	No

- Note 1 Probability: L low (all necessary documentation has been reviewed and there is no recorded instance or compelling rationale); M moderate (all necessary documentation has been reviewed and there is potential evidence of a recorded instance with compelling rationale); H high (all necessary documentation has been reviewed and there is evidence of a recorded instance with compelling rationale).
- Note 2 Activities listed in Appendix B of NEMP (2020).
- Note 3 Runoff from up-gradient PFAS use may impact surface water, soil, sediment and groundwater.
- Note 4 PFAS is used wide range of industrial processes and consumer products, including in the manufacture of nonstick cookware, specialised garments and textiles, Scotchguard™ and similar products (used to protect fabric, furniture, leather and carpets from oils and stains), metal plating and in some types of fire-fighting foam. (https://www.nicnas.gov.au/chemical-information/factsheets/chemical-name/perfluorinated-chemicals-pfas)
- Note 5 Refer to https://www.epa.nsw.gov.au/your-environment/contaminated-land/pfas-investigation-program.

4.3.3 Emerging Chemicals

The EPA uses Chemical Control Orders (CCOs) as a primary legislative tool under the *EHC Act* 1985, to control chemicals of concern and limit their potential impact on the environment. Considerations for chemicals controlled by CCOs, and other potential emerging chemicals, are outlined in Error! Reference source not found..

In this instance, the potential for an emerging chemical of concern to be present on-site was limited to the application of organic pesticides (around building footings and perimeters).



Table 4-2 Emerging or Controlled Chemicals

Chemicals of Concern (CCO or emerging)	Decision
Were aluminium smelter wastes used or stored on site (CCO, 1986)?	No
Do dioxin contaminated wastes (CCO, 1986) have the potential to impact the site? 1	No
Were organotin products (CCO, 1989) used or stored on site? ²	No
Were polychlorinated biphenyls (PCBs) used or PCB wastes (CCO, 1997) stored on-site? 3	No
Were scheduled chemical or wastes (CCO, 2004) used or stored? ⁴	Potential for organic pesticides to have been used
Are other emerging chemicals suspected? 5	No
If Yes to any questions, has site sampling suite been optimised to include sampling for these chemicals of concern?	Υ

- Note 1 From burning of certain chemicals, smelting or chemical manufacturing or fire on or near the site.
- Note 2 From anti-fouling paints used or removed at boat and ship yards and marinas.
- Note 3 From older transformer oils and electrical capacitors
- Note 4 Twenty-four mostly organochlorine pesticides and industrial by-products
- Note 5 Other chemicals considered as emerging (e.g. 1,4 dioxane; associated with some CVOC).

4.4 Potential Sources, Exposure Pathways and Receptors

El considered there was low potential for contamination to be present on-site. Fill soils of unknown origin, uncontrolled demolition of structures, pesticide use and parked vehicles (leaks) were considered to present the only potential sources of contamination.

A qualitative assessment of the exposure pathways and human and environmental receptors related to these potential sources is summarised in **Table 4-3**. The risks to these receptors were considered to be low.



Table 4-3 Conceptual Site Model

Potential Source	Impacted Medium	COPC	Transport Mechanism	Exposure Pathway	Potential Receptor
Fill soils of unknown origin and quality Weathering of existing / former building fabrics containing hazardous substances Historic pesticide use Leakage from (parked) vehicles	Soil	PM, TRH, VOC (including BTEX), PAH, OCP, OPP, PCB, asbestos	Disturbance of surface and subsurface soils during site redevelopment Future site maintenance and future use of the site post redevelopment	Ingestion Dermal contact Inhalation of dust particulates	Construction and maintenance workers Adjacent site users
			Atmospheric dispersion from soil to outdoor and indoor air spaces	Inhalation dust particulates	
			Volatilisation of contamination from soil and diffusion to indoor air spaces	Inhalation of vapours from impacted soil	
	Groundwater	Dissolved PM, TRH, VOC (including BTEX)	Volatilisation of contamination from groundwater to indoor or outdoor air spaces (onsite and offsite)	Inhalation of vapours	Construction and maintenance workers Basement users
			Potential seepage into deep basement intercepting water table (offsite and onsite)	Dermal contact Ingestion	Construction and maintenance workers Basement users



5. Conclusion

The property identified as 45 McLaren Street, North Sydney NSW was the subject of a Preliminary Site Investigation, the main objective being to appraise the potential for contamination. The key findings of this PSI were as follows:

- The history review indicated that site use had been residential since the early 1900s, at least. Initially, the site was comprised of three residential dwellings (houses). In (or by) 1970, the land was cleared, and then redeveloped into a multi-level, residential apartment building (which has remained to the present time).
- Surrounding land uses were predominantly low to medium density residential (i.e. on-going since the early 1900s, at least).
- There was no evidence that an industrial activity of significance had ever occurred, either on-site, or in the surrounding area.
- The site and neighbouring properties (≤250m radius) were free of statutory notices and licensing agreements issued under the Contaminated Land Management Act 1997 and Protection of the Environment Operations Act 1997. The site was not included on the List of NSW Contaminated Sites Notified to the EPA.
- Visual evidence of gross contamination, including fragments of FCS, was not observed on any part of the site. No suspicious odour was detected during the site inspection.
- There was no evidence that a UST was present on the site. No AST was identified.
- The potential for ASS to be present on the site was extremely low.
- The CSM established that the potential for site contamination was low.

Based on the findings of this PSI and with due consideration of El's Statement of Limitations (**Section 7**), it was concluded that the site is not likely to be contaminated. Provided that appropriate waste soil classification is undertaken following building demolition, El believes that the site will be suitable for the proposed development, in accordance with *State Environmental Planning Policy* 55 (SEPP 55) - *Remediation of Land*.



6. Recommendations

El provide the following recommendations in relation to any future development of the property:

- Before commencement of any demolition works, a Hazardous Materials Survey (HMS) should be completed by a suitably qualified consultant, to identify any hazardous materials present within the existing building fabrics.
 - If present, all identified hazardous materials must be appropriately managed, to maintain worker health and safety during demolition works and prevent the spread of hazardous substances.
 - An asbestos clearance inspection and certificate should be completed by a suitably qualified professional (SafeWork NSW Licensed Asbestos Assessor) following the removal of all ACM from the site (if identified).
 - Where clearance inspection indicates the presence of hazardous materials remaining on the site, further removal and validation works must be undertaken.
- Following demolition of buildings, all soils to be disposed off-site as part of the proposed (bulk) basement excavation and foundation works, including any virgin excavated natural material (VENM), are to be pre-classified in accordance with the EPA (2014a) Waste Classification Guidelines. Such tasks will form part of a Soil Management Plan for the site.
- Any soil materials designated for onsite retention in road alignments, beneath site structures or landscaping / set-back areas, must be sampled in accordance with NEPC (2013), analysed by a NATA accredited laboratory and meet the applicable human health / ecological acceptance criteria.
- Although not expected, any (abandoned) UST infrastructure encountered on-site during the proposed development must be removed in accordance with the EPA (2014b) Technical Note: Investigation of Service Station Sites and AIP (1994) Code of Practice for the Removal and Disposal of Underground Petroleum Storage Tanks. The Protection of the Environment Operations (Underground Petroleum Storage Systems) Regulation 2019 will also apply.
- Any material being imported to the site should be validated as suitable for the intended use in accordance with EPA guidelines.



7. Statement of Limitations

This report has been prepared for the exclusive use of 45 McLaren Pty Ltd, whom is the only intended beneficiary of El's work. The scope of the investigation carried out for the purpose of this report was limited to that agreed with 45 McLaren Pty Ltd.

No other party should rely on this document without the prior written consent of EI, and EI undertakes no duty, or accepts any responsibility or liability, to any third party who purports to rely upon this document without EI's approval.

El has used a degree of care and skill ordinarily exercised in similar investigations by reputable members of the environmental industry in Australia, as at the date of this document. No other warranty, expressed or implied, is made or intended. Each section of this report must be read in conjunction with the whole of this report, including its appendices.

The conclusions presented in this report are based on a limited assessment of historical and current uses of the site. Due to the preliminary nature of this investigation, findings are not based on actual samples collected or testing conducted. El has relied upon information provided by the Client and other third parties to prepare this document, some of which could not be verified by El due to the anecdotal or historical nature of the information.

El's professional opinions are reasonable and based on its professional judgment, experience and training.

El's professional opinions contained in this document are subject to modification if additional information is obtained through the data searches that have been initiated with government authorities.

Technical opinions may also be amended in the light of further investigation, observations, or validation testing and analysis during remedial activities. In some cases, further testing and analysis may be required, which may result in a further report with different conclusions.



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Abbreviations

ACM Asbestos-Containing Materials
AHD Australian Height Datum

ASS Acid Sulfate Soils

AST Above-ground Storage Tank

 $B(\alpha)P$ Benzo(α)pyrene BGL Below Ground Level

BTEX Benzene, Toluene, Ethylbenzene, Xylenes

CBD Central Business District
CCO Chemical Control Order

CLM Contaminated Land Management COPC Contaminants of Potential Concern

CSM Conceptual Site Model

CVOC Chlorinated Volatile Organic Compounds (a sub-set of the VOC suite)

DA Development Application

DP Deposited Plan

DSI Detailed Site Investigation

El El Australia

EPA Environment Protection Authority (of New South Wales) F1 C_6 - C_{10} TRH (less the sum of BTEX concentrations) F2 $>C_{10}$ - C_{16} TRH (less the concentration of naphthalene)

FCS Fibre Cement Sheeting

GIPA Government Information Public Access

HMS Hazardous Materials Survey

km Kilometres L Litres

LEP Local Environmental Plan LGA Local Government Area

m Metres

NATA National Association of Testing Authorities, Australia

NEPC National Environmental Protection Council
NEPM National Environmental Protection Measure

NSW New South Wales

OCP Organochlorine Pesticides

OEH Office of Environment and Heritage (of New South Wales)

OPP Organophosphorus Pesticides PAH Polycyclic Aromatic Hydrocarbons

PCB Polychlorinated Biphenyls

PFAS Per- and Poly-Fluoroalkyl Substances
POEO Protection of the Environment Operations

PM Priority Metals (arsenic, cadmium, chromium, copper, lead, mercury, nickel, zinc)

PSI Preliminary Site Investigation

SCID Stored Chemical Information Database (maintained by SafeWork NSW)

SEPP State Environmental Planning Policy

TPH Total Petroleum Hydrocarbons (term / analyte superseded by TRH)


TRH Total Recoverable Hydrocarbons (non-specific analysis of organic compounds)

UPSS Underground Petroleum Storage System

UST Underground Storage Tank
VENM Virgin Excavated Natural Material
VOC Volatile Organic Compounds



Appendix A - Figures

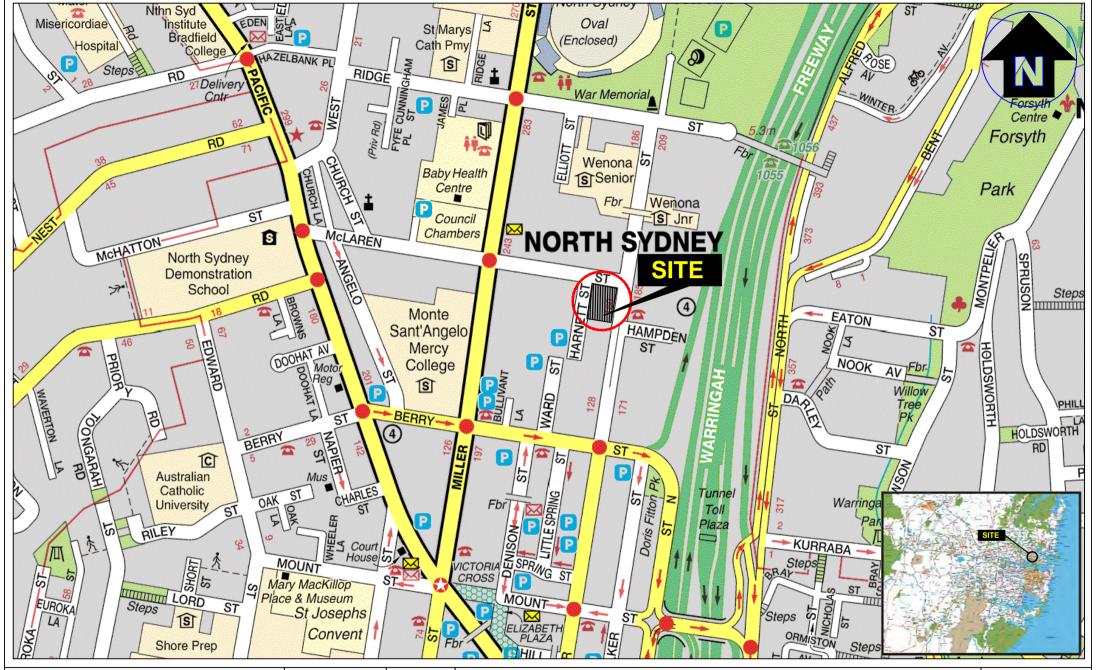



Drawn: L.C.

Approved:
Date: 09-07-20

Scale: Not To Scale

Podia Pty Ltd

Preliminary Site Investigation 45 McLaren St, North Sydney NSW

Site Locality Plan

Figure:

1

Project: E24748 E01



LEGEND

Approximate site boundary




Drawn:	L.C.
Approved:	-
Date:	09-07-20

Podia Pty Ltd Preliminary Site Investigation 45 McLaren St, North Sydney NSW Site Layout Plan

Figure:

2

Project: E24748 E01

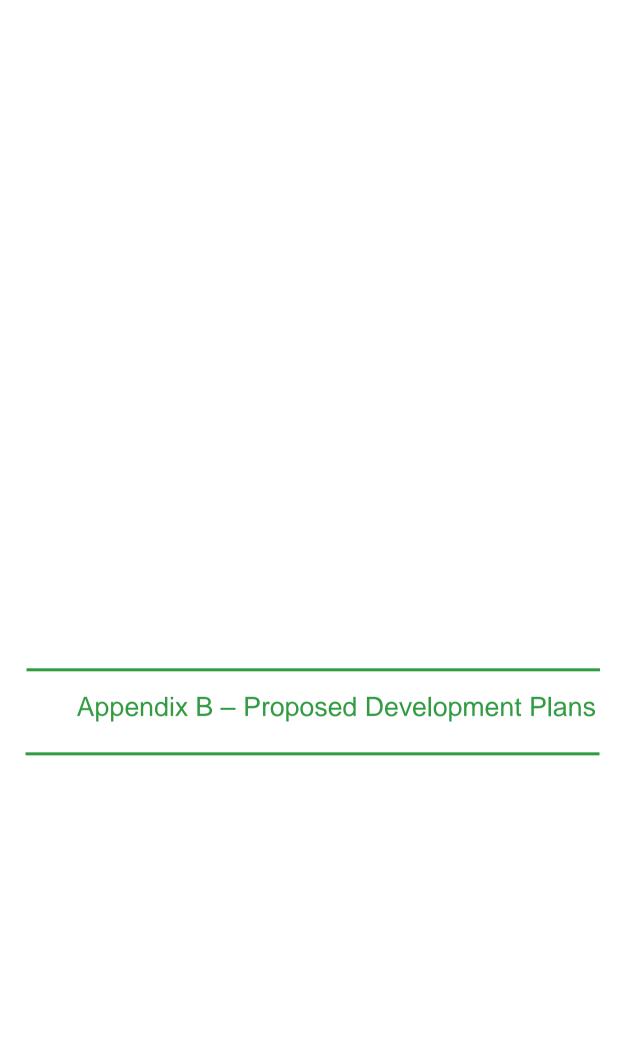



CLIENT

45 McLaren Pty Limited (ACN 641 204 024) ATF AIDOP No 4 Unit Trust

podia

CONSULTANTS

Architect Bates Smart
Planning Urbis
Landscape Arcadia
Traffic Traffix

PROJECT NUMBER

s12400

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VISION

Our vision is for a sustainable, **carbon-neutral mixed-use building** that celebrates the site's location at the transition between North Sydney's high density CBD and North Sydney's Civic Precinct.

Our massing approach proposes a series of **stepped and staggered landscaped rooftops, which transition** between the low-mid scale residences located south of the site, to the tall residential towers directly north of the site.

The design intends to complement and enhance the Ward Street Masterplan through building articulation and amenity. Its stepped and staggered massing provides solar access to the proposed public plaza within the Ward Street Precinct, and the residential apartments directly south of the site.

The podium complements the site's lower-scale density, fine-grain heritage and leafy character along Walker Street, as well as the mixed-use character along McLaren Street.

The proposal seeks to further enhance the **pedestrian permeability** from Harnett Street through to Walker Street on the southern side of the building.



DEVELOPMENT SUMMARY

This design report has been prepared by Bates Smart on behalf of Podia and forms part of the planning proposal for the site at 45 McLaren Street, North Sydney. It describes a planning and massing strategy for a new mixed-use building at the corner of Walker and McLaren Street in the fringe of the North Sydney CBD.

TOTAL FLOOR SPACE

Site Area 1,792 sqm
Residential GFA 11,083 sqm
Retail / Comm GFA 2,168 sqm
Total GFA 13,251 sqm
FSR 7.5 :1
Maximum Height 61 m

Storeys 16 storeys @ north boundary
Storeys 12 storeys @ south boundary


RESIDENTIAL MIX

Dwellings 100 units

Comprising 17 one bedroom apartments

65 two bedroom apartments18 three bedroom apartments

PARKING 178 car spaces

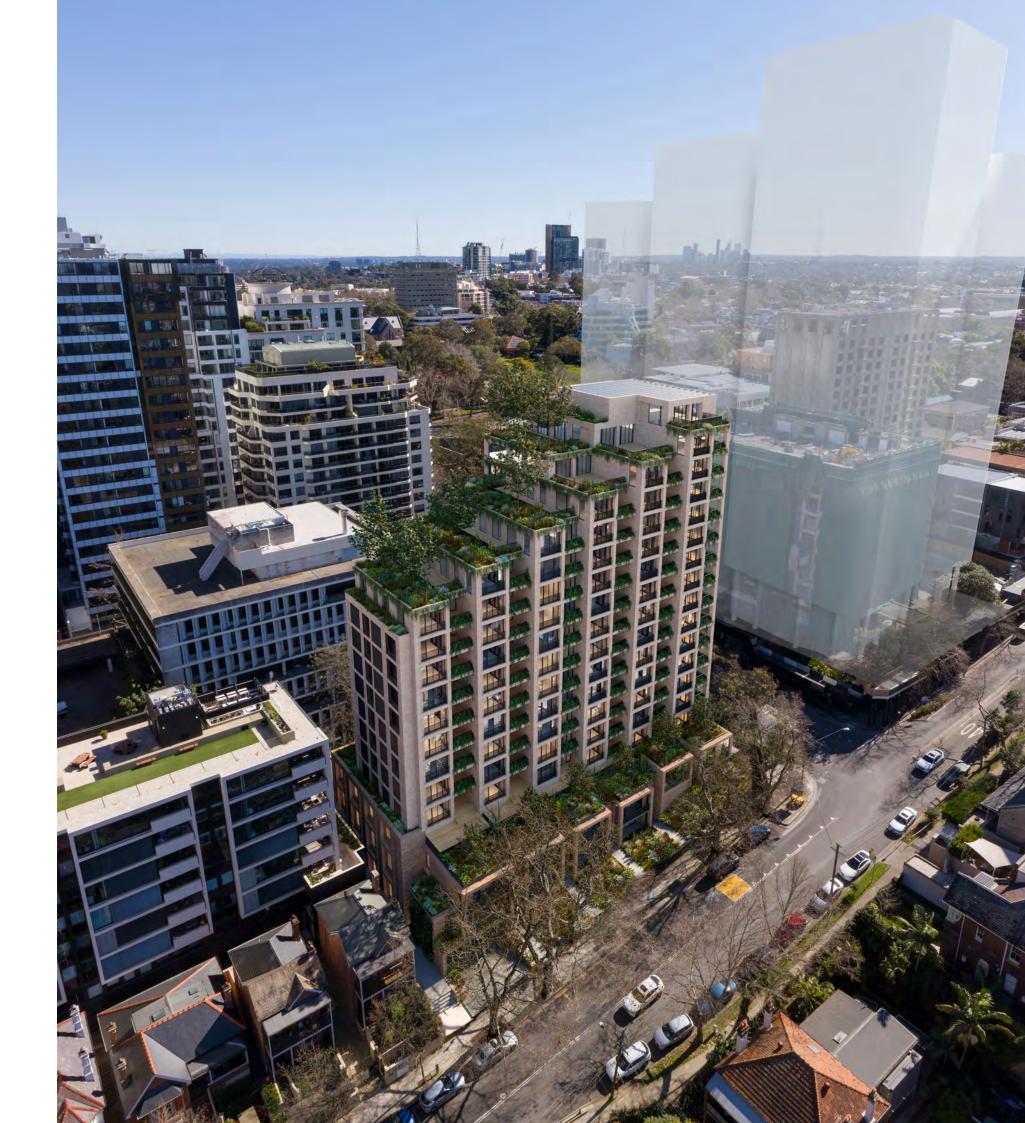




SITE

The site is located on the corner of Walker Street and McLaren Street in North Sydney, the transition point between North Sydney CBD, the Ward Street Masterplan and the North Sydney Civic Precinct. The site has frontages to Walker, McLaren, and Harnett streets, with a pedestrian through-site link to the south of the site, that connects Walker and Harnett streets.

It is less than 200m from the Victoria Cross Metro north entry, less than 400m from the Victoria Cross Metro south entry, and is directly opposite the recently D.A. approved residential tower, 168 Walker Street.



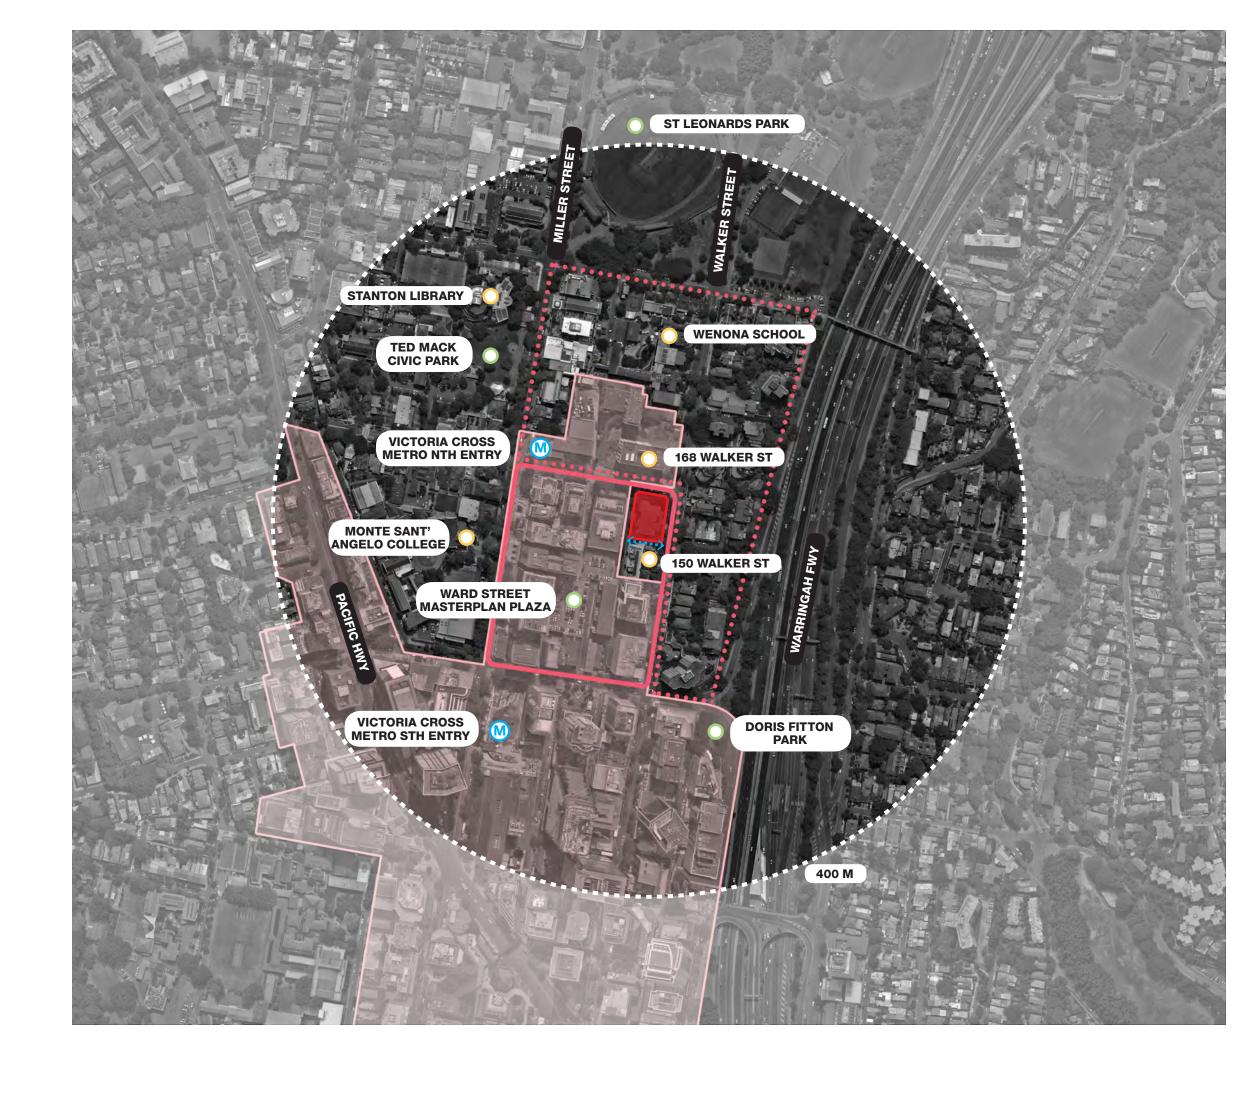

SITE

KEY

- 1. Walker Street looking north
- 2. 45 McLaren Street eastern frontage and steep topography
- 3. Southern through-site link between 45 McLaren Street and 150 Walker Street
- 4. 150 Walker Street heritage buildings
- 5. Heritage facade of 150 Walker Street along the through-site link
- 6. Through-site link from Harnett Street
- 7. 168 Walker Street approved D.A.
- 8. Victoria Cross Metro OSD approved D.A.
- 9. Corner of McLaren Street and Walker Street
- 10. View of Harnett Street looking south
- 11. Victoria Cross Metro Northern Entry, corner of McLaren Street and Miller Street


























SITE LOCATION


The site is located on the corner of Walker Street and McLaren Street in North Sydney, the transition point between North Sydney CBD, the Ward Street Masterplan and the North Sydney Civic Precinct. The site has frontages to Walker, McLaren, and Harnett streets, with a pedestrian through-site link to the south of the site, that connects Walker and Harnett streets.

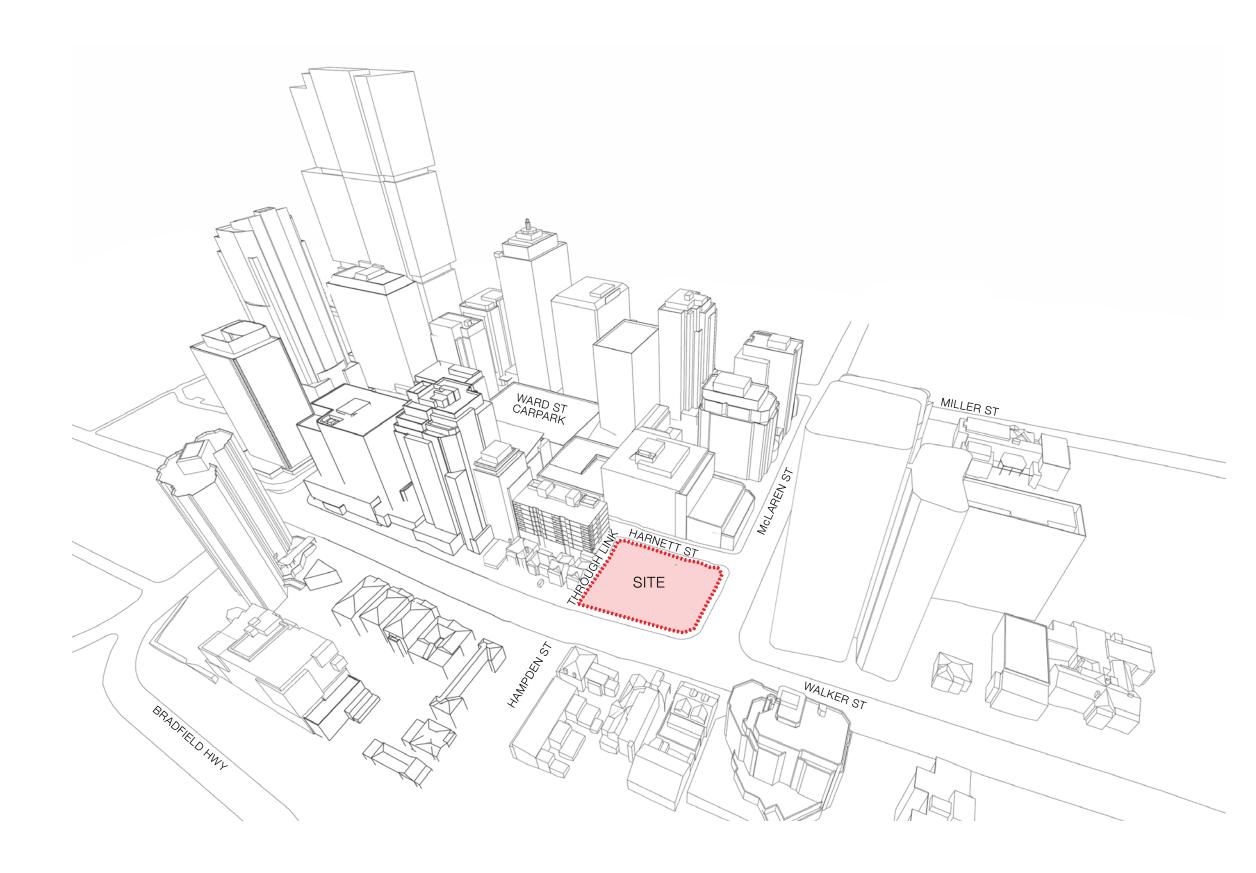

SITE TOPOGRAPHY

The site has a 9m fall towards the southeast, from a high point on McLaren Street in the northwest of RL68.5, to a low point on southeast frontage of Walker Street of RL59.8.


Along the frontage of Walker street, the site has a 7m fall towards the south, whilst the frontage along Harnett Street has a 3.5m fall towards the south.

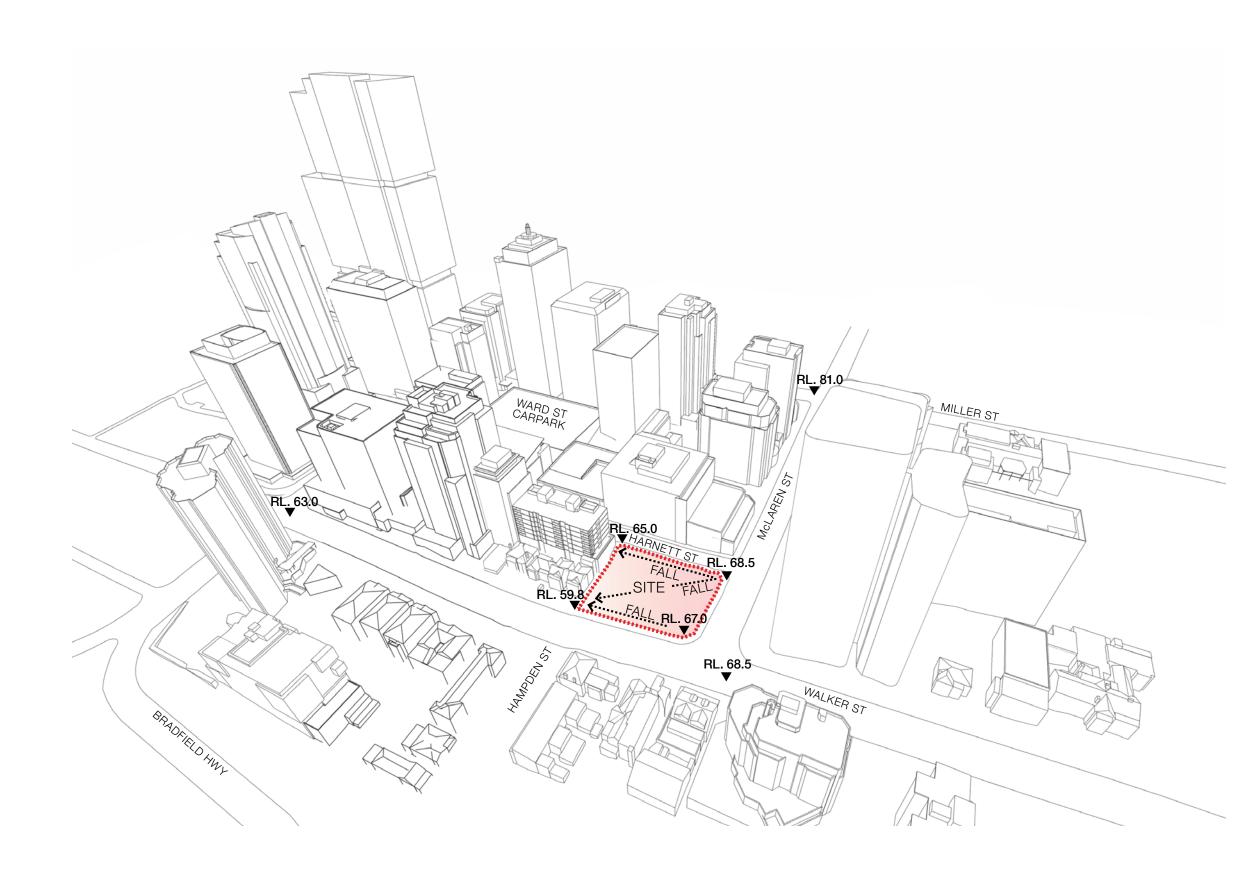

SITE SOLAR


The site is predominantly east-west facing. To the south and east of the site are two-storey heritage buildings. These low-scale volumes provide opportunity for solar access into the site.

Solar access is limited to the north and west of the site, which is prohibited by a mid-rise tower on the west, and a DA approved tall tower to the north.

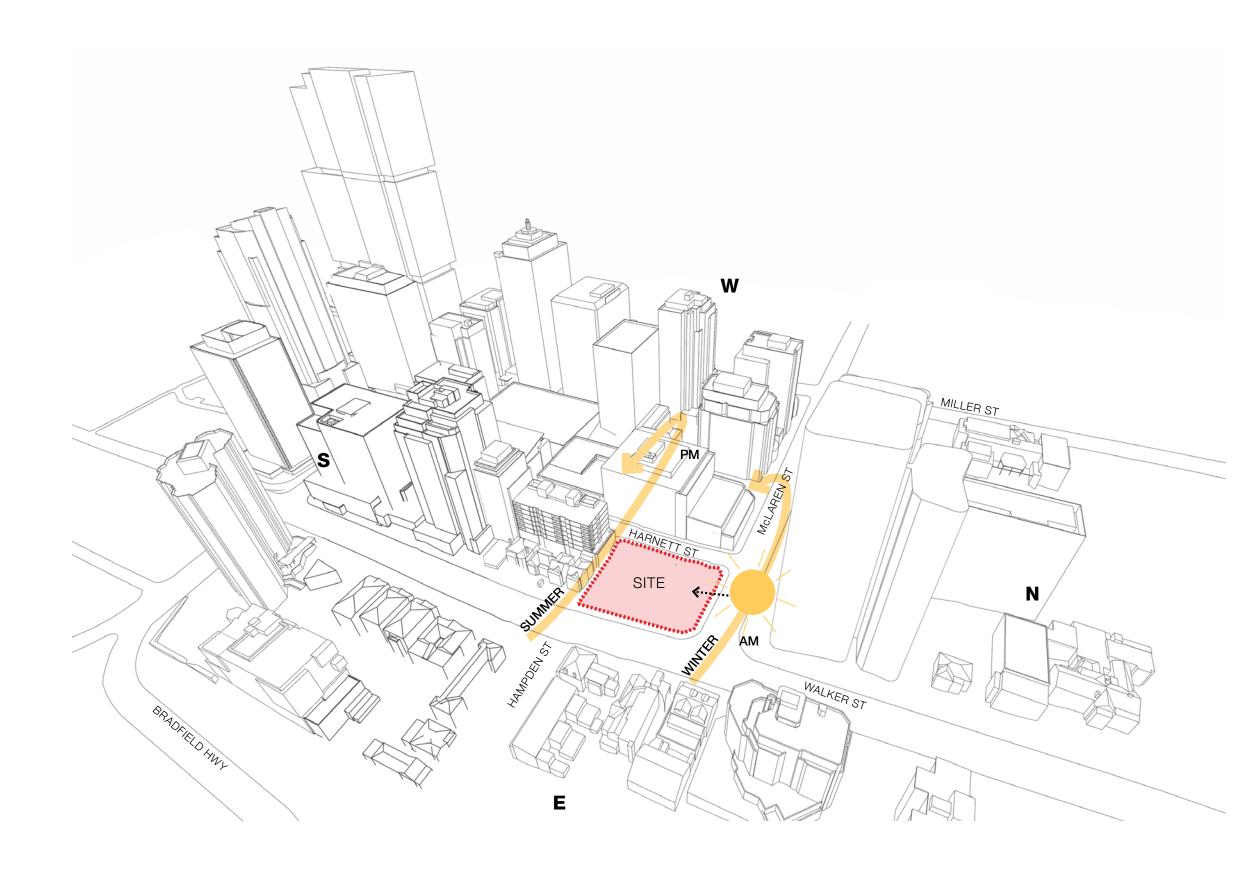

SITE VIEWS

To the east and north-east of the site are views to the lower North Shore and Neutral Bay areas. The the southwest are views towards the Sydney Harbour. Views to the northwest have district views of the North Sydney Civic Precinct.

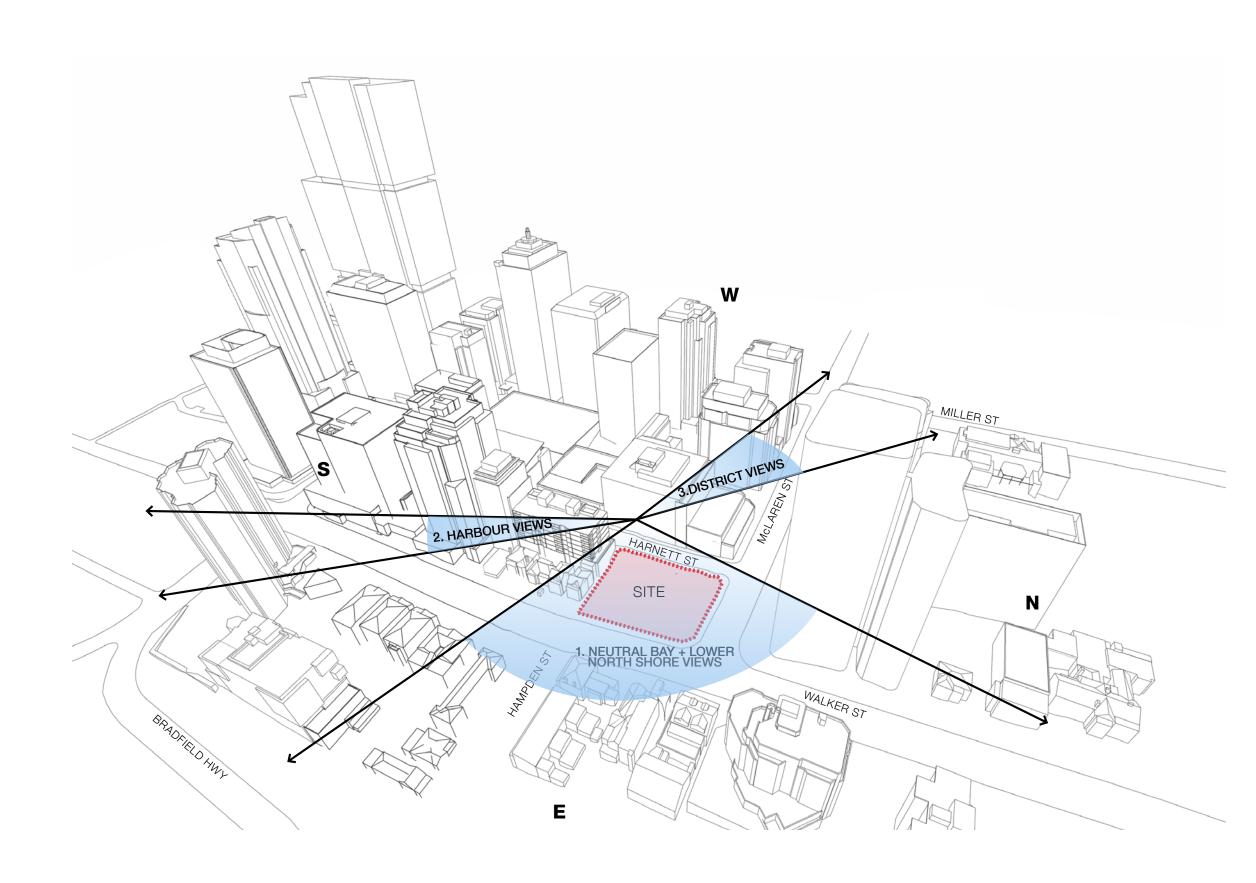


SITE PEDESTRIAN MOVEMENT

The predominant pedestrian movement in North Sydney is north-south along Miller Street. This is representative of the movements to & from the North Sydney Train Station, the Victoria Cross Metro and the buses that travel along Miller Street.


Parallel to this is a proposed throughsite link as part of North Sydney's future vision, connecting Elliot and Denison Street to the Metro portals

The site is 100m from the northern access point of the Victoria Cross Metro located on the corner of McLaren and Miller streets, which is a 1minute walking distance. It is a 6minute walking distance, or 400m, from the southern access point of the Victoria Cross Metro.

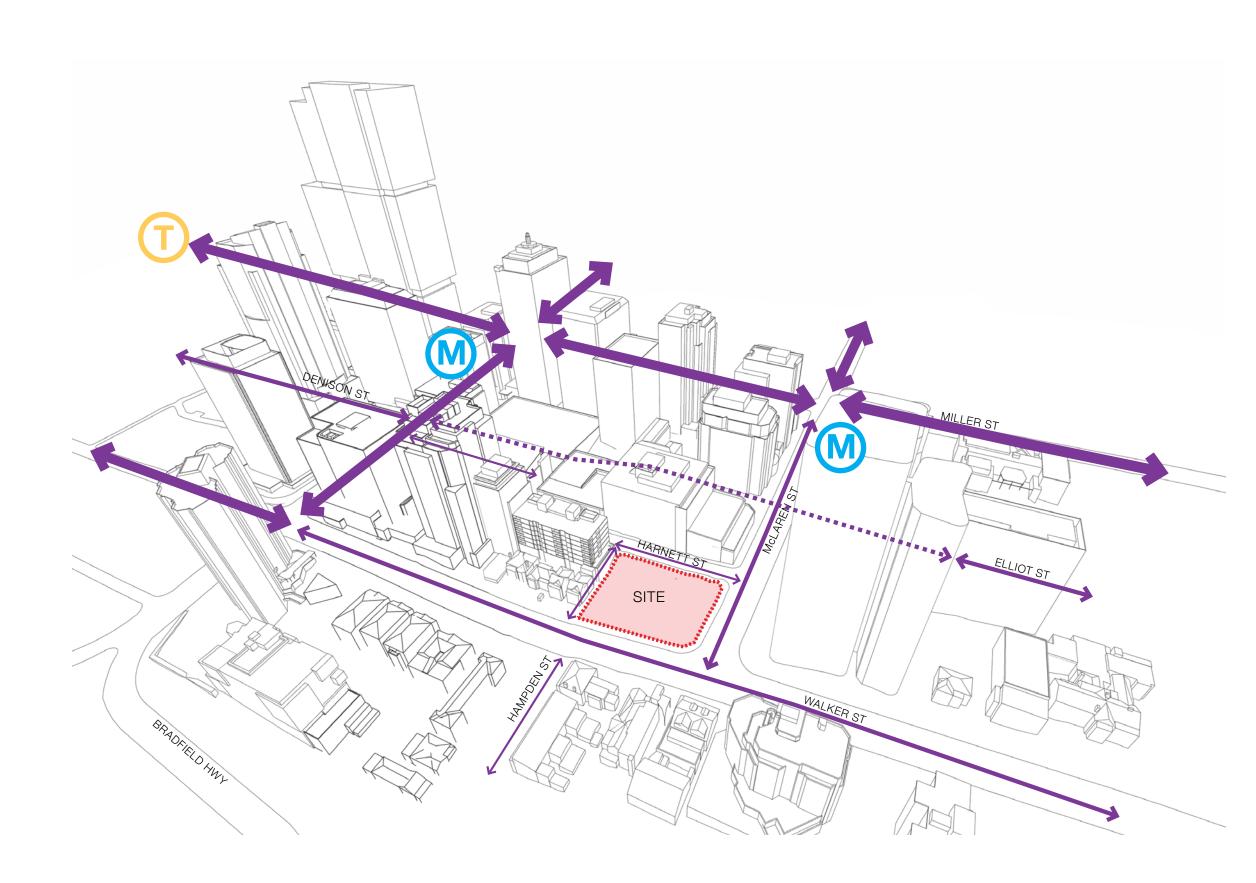

SITE VEHICULAR MOVEMENT


Miller Street is the primary northsouth vehicular street through North Sydney that connects Blues Point Road in the south, to Crows Next in the north. Berry Street heading east is the primary feeder route to access the M2 Freeway. Walker and McLaren streets feed off these two primary streets.

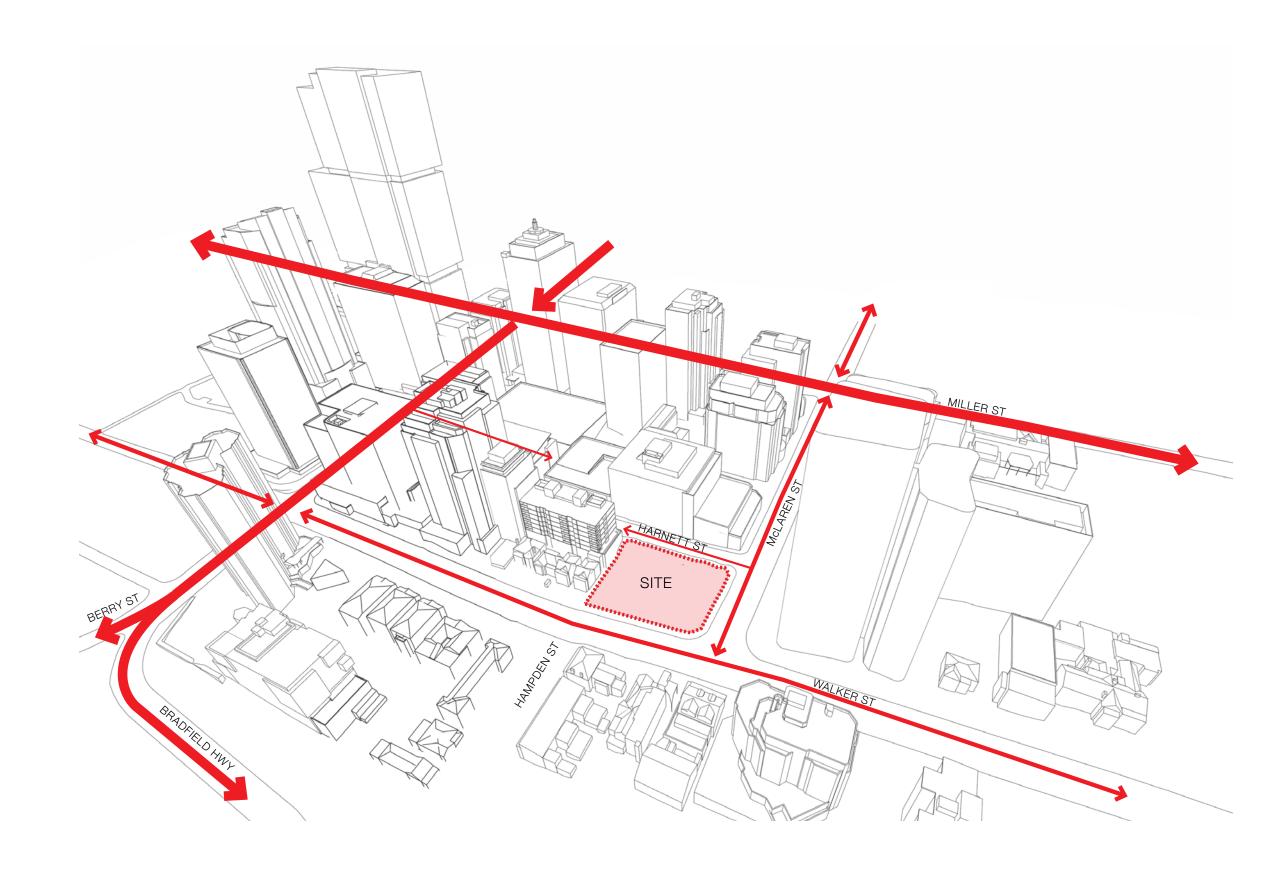

SITE HERITAGE

There are a number of locally-listed heritage buildings surrounding the site. To the south is 150 Walker Street, consisting of elevated 2-storey individual terraces with outdoor balconies to both levels, and direct street access with generous landscaping. Similarly, east of the site are elevated 2-storey terraces with shared walls, balconies to both levels, and stair access directly from Hampden Street. 185 Walker street, which is to the north-east of the site, consists of individual heritage buildings with a 2-3 storey scale. To the west is 41 McLaren Street, a commercial building by Harry Seidler, with rooftop terraces that step down towards McLaren Street.

Further north of the site is the locally-listed Walker / Ridge street conservation area and the state-listed St Leonards Park.

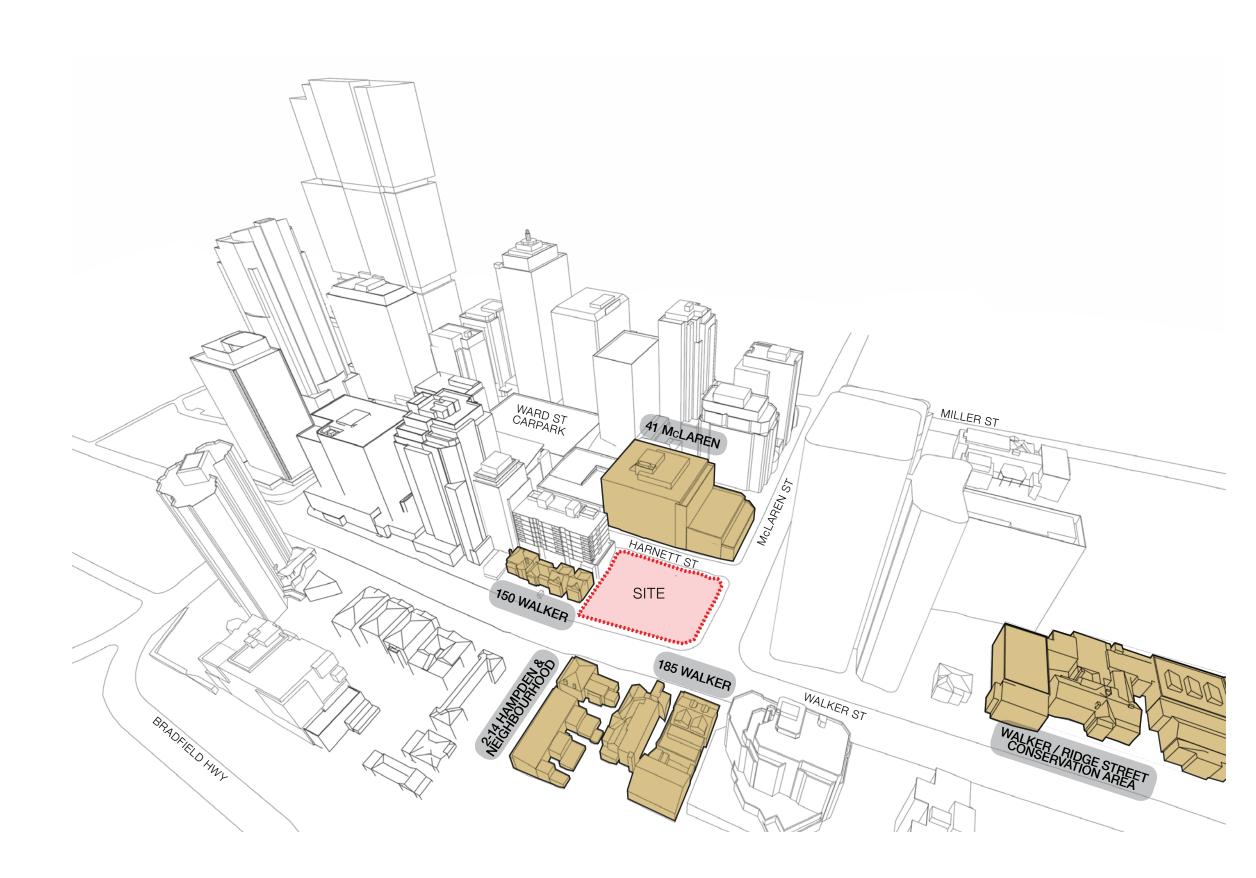

SITE HERITAGE

KEY

- 1. 150 Walker street terraces
- 2. 2-4 Hampden street
- 3. 6-14 Hampden street
- 4. 41 McLaren street
- 5. 185 Walker street6. 185 Walker street
- 7. Walker / Ridge st conservation area / 207 Walker street
- 8. Walker / Ridge st conservation area / Wenona School
- 9. Walker / Ridge st conservation area / 85 Ridge street






















SITE TOWER SETBACKS

There is a consistent tower street alignment running close to the site boundaries along McLaren Street.


Walker Street on the other hand, consists of varied street setbacks ranging from 5m to 20m.

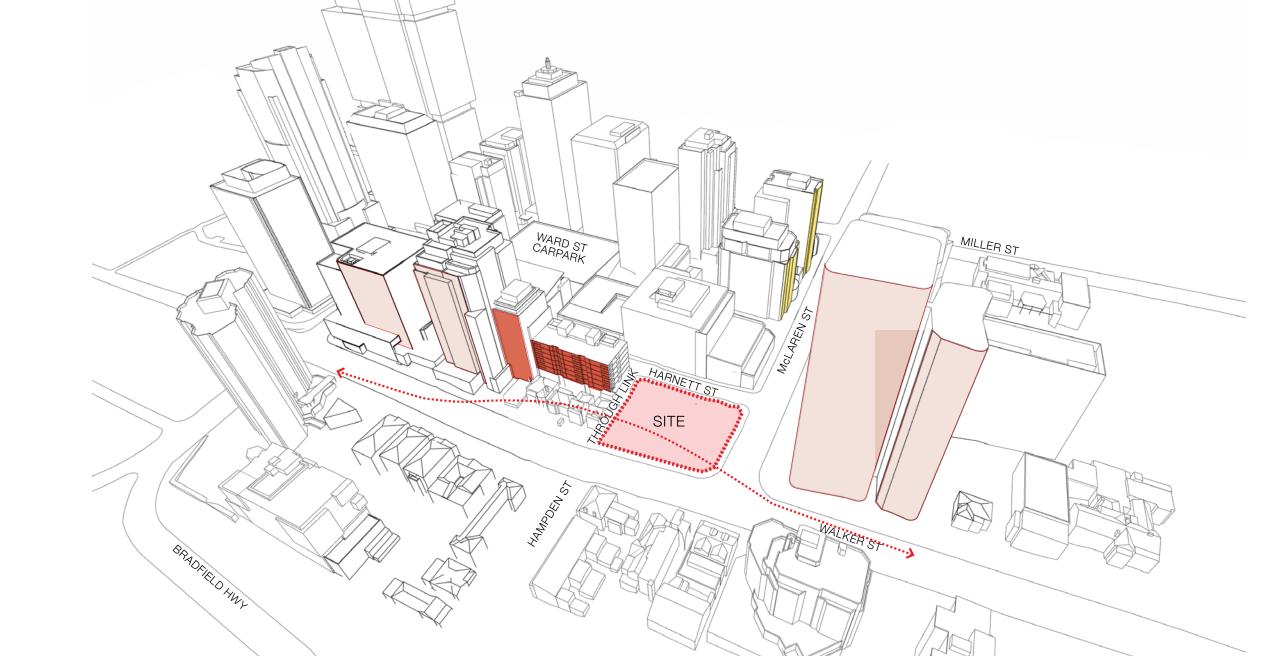



SITE CURRENT CONTEXT / BUILDING USE

North Sydney CBD, located southwest of the site has a current context of commercial buildings of varied heights. The building heights and usage transition between commercial and residential as it tapers away from the Commercial Core, where in close proximity to the site are a cluster of low to mid-rise residential uses. However, north of the site is a recently approved residential tower at RL168. Further north of this is Wenona School, which consists of a cluster of low to mid-rise buildings.

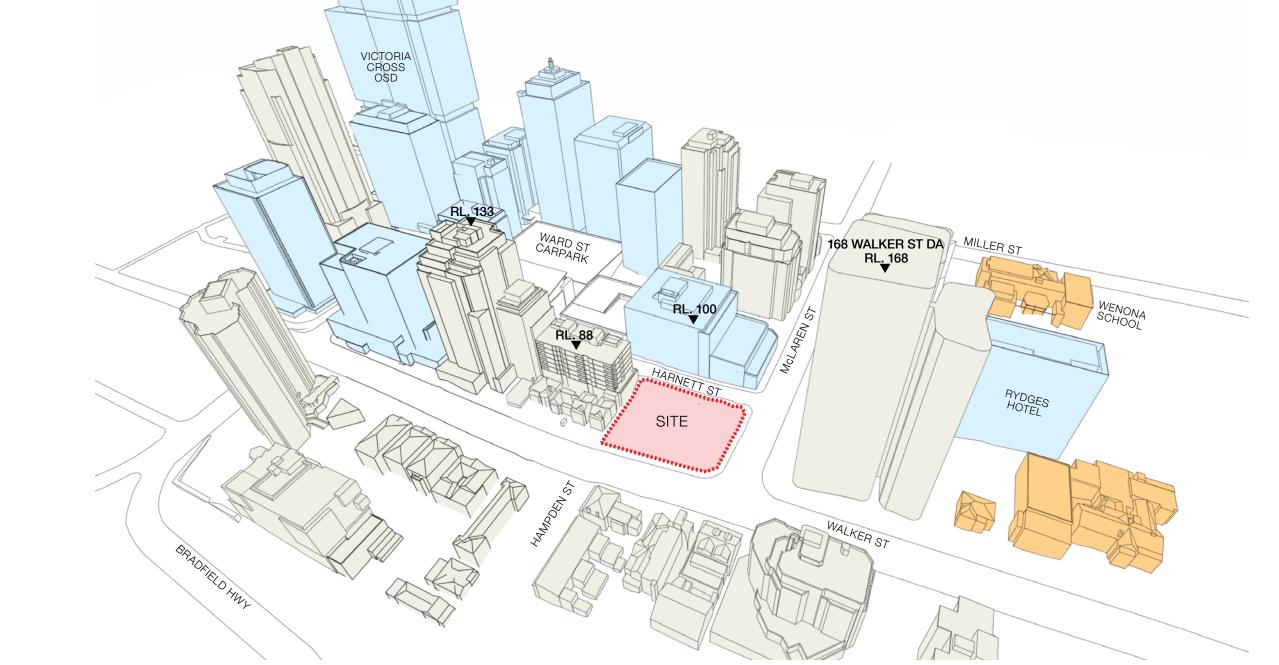

VICTORIA CROSS OSD RL._230





SITE FUTURE CONTEXT


North Sydney is seeking to undertake significant uplift, with a future cluster of high-rise towers developing around the Victoria Cross OSD, known as the Ward Street Masterplan, and along the fringe of North Sydney CBD, known as the Civic Precinct Study. There is also a recently approved residential tower north of the site, known as 168 Walker Street, and a gateway determined planning proposal southeast of the site, known as East Walker Street.



civic precinct study

planning proposal - gateway determined

approved DA

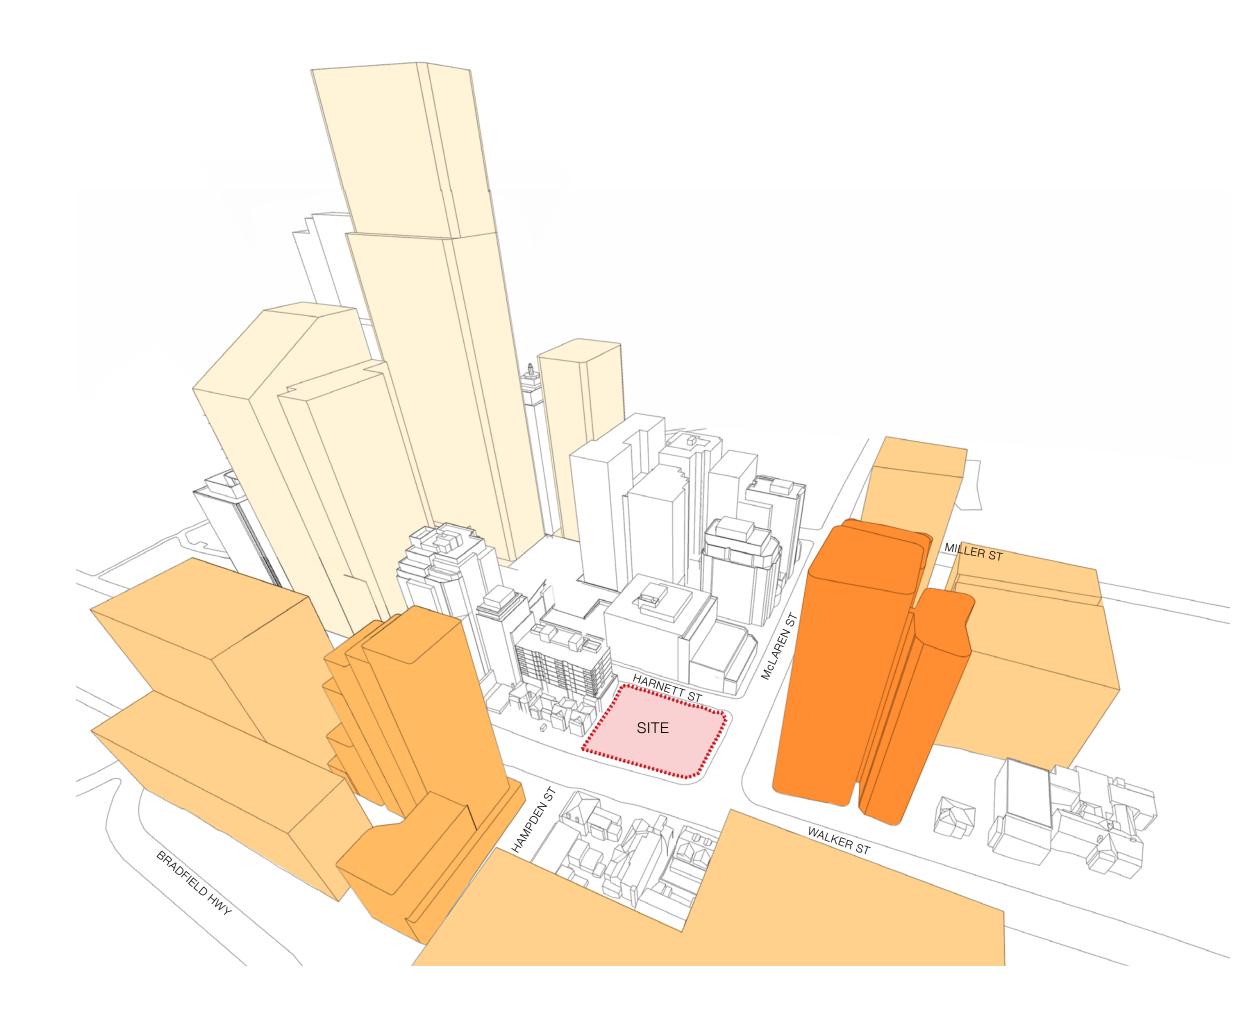




CURRENT PLANNING CONTROLS

LAND ZONING

The site is zoned as High Density Residential (R4) under the North Sydney LEP 2013.

FLOOR SPACE RATIO

The site is not restricted by a maximum floor space ratio, based on the North Sydney LEP 2013.

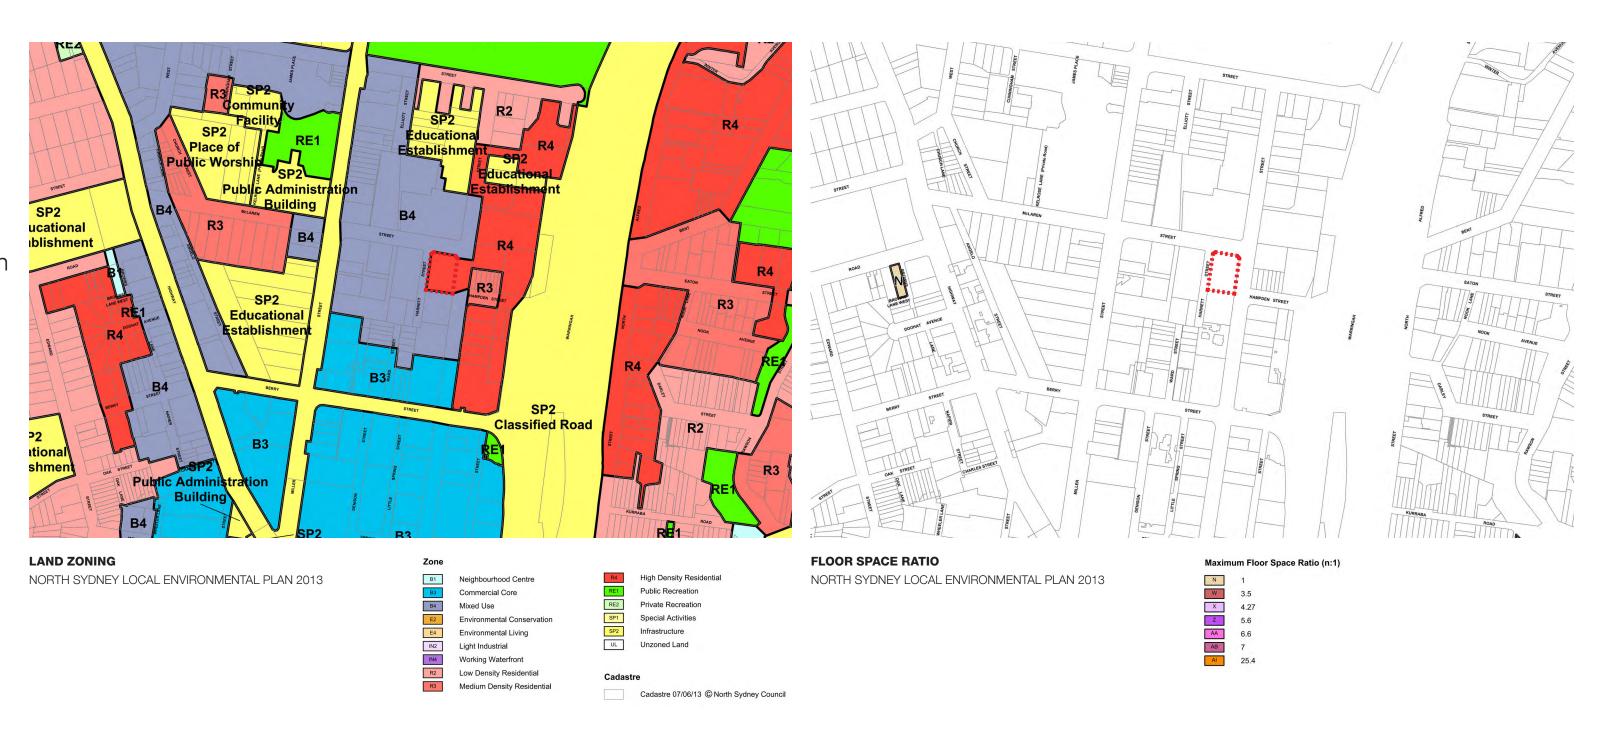

CURRENT PLANNING CONTROLS

HEIGHT OF BUILDINGS

The maximum building height is 12m.

HERITAGE

No part of the site is listed in the North Sydney LEP 2013 as a Heritage Item. However the lots directly south, east and west of the site are local-heritage listed.



STRATEGIC FRAMEWORK - INTRODUCTION

In 24 June 2019, Council resolved to endorse the Ward Street Master Plan. Whilst the Final WSMP did not provide uplift on the site, Council's resolution recommended that:

"despite the preferred Masterplan option, a landowner initiated Planning Proposal may be considered from 45 McLaren Street and may identify how any future redevelopment will:

- 1/ minimise solar reductions upon new public domain as identified in the Masterplan.
- 2/ minimise solar and privacy impacts upon existing residential development.
- 3/ provide for a commercial component to any redevelopment.
- 4/ identifies significant **public benefits** that will arise from the development of the site with particular **regard to the objectives of the Masterplan**."

The principles provided have guided the built form modelling presented within the Pre-DA package, whilst also incorporating the Place Principles from the WSMP and the objectives of the draft Civic Study.


Specifically, the **conceptual building** envelope has been modelled to result in:

- / minimal additional overshadowing to the central plaza
- 2/ limited solar impact to 150 Walker Street
- 3/ integration of a mix of residential and retail and/or commercial uses
- 4/ active retail frontage to McLaren Street and Walker Street
- 5/ provision of an **enhanced through-site link** connecting Walker Street to Harnett Street
- 6/ a sustainable carbon-neutral building

WARD STREET MASTERPLAN

BUILDING UPLIFT

The Ward Street Masterplan was developed based on an interactive design process with North Sydney. It sought to provide significant uplift in FSR and building height to strengthen the commercial centre created by the Victoria Cross metro. It underwent several stages of development options.

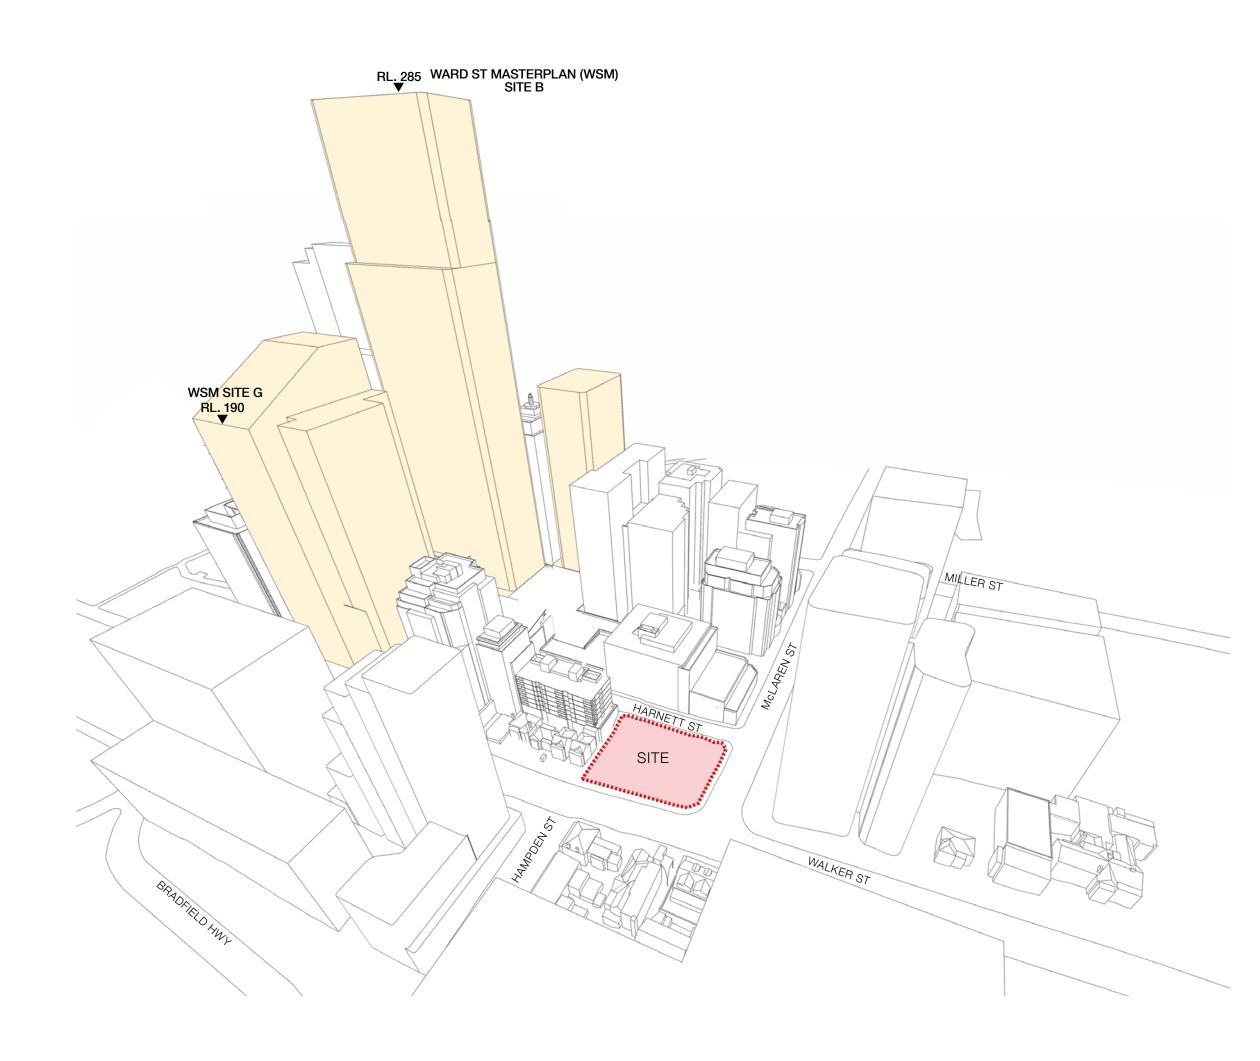


WARD STREET MASTERPLAN

WARD STREET PLAZA

The Public Domain Design for the Ward Street Masterplan incorporates the Ward Street Plaza at the centre of the masterplan, as well as a pocket park immediately north of the Plaza.

SITE CONCEPT CONSIDERATION

The site aims to build on the strategy of strengthening the building uplift created by the Victoria Cross Metro through a mixed-use offering, whilst still providing good solar access to the centra plaza.

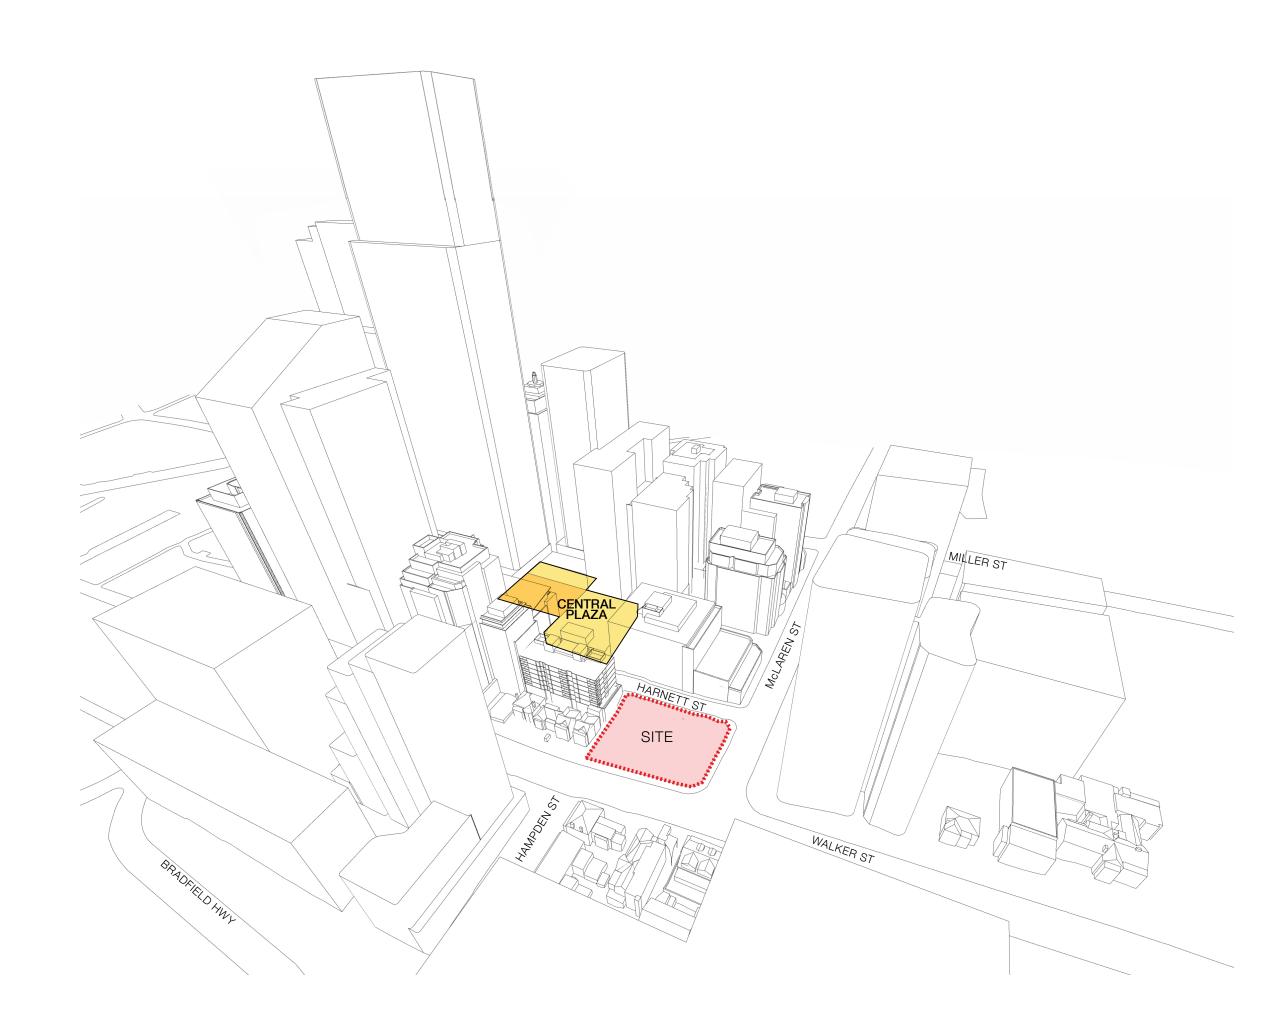

WARD STREET MASTERPLAN

OPTION 1

Option 1 proposed a mid-rise building on the site of 45 McLaren Street with an RL144, circa 16,750sqm of GFA and a proposed FSR of 9:1. It acknowledged that this site was suitable for hotel or residential floor space.


OPTION 2


Option 2 ommited any additional building height to 45 McLaren Street. This reduced diversity of land use as compared to option 2 in order to provide solar access to the proposed central plaza in mid-winter.

FINAL MASTERPLAN

The final masterplan includes building heights that exceed the Victoria Cross OSD at RL285, and concentrates the building uplift on the southern portion of the Ward Street Masterplan, consequently reducing diversity in building height and land use. An additional pocket park was proposed north of the central plaza.



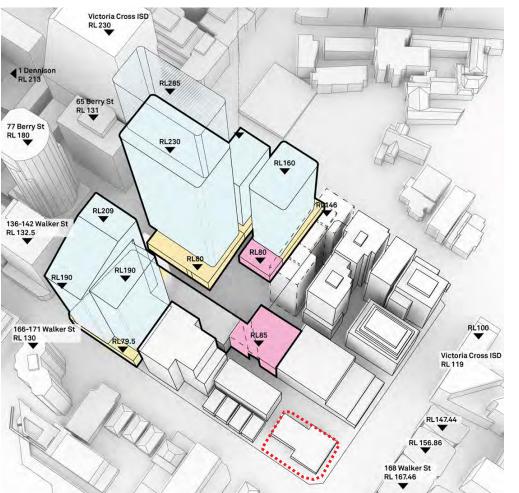

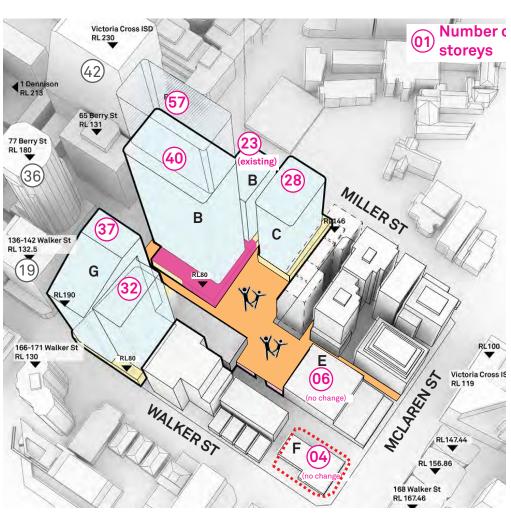

OPTION 1

OPTION 2

FINAL MASTERPLAN

BATESSMART


SITE SOLAR CONSTRAINTS

SOLAR ACCESS

The North Sydney Public Domain Strategy, highlights public domain areas and the required solar access to these zones:


/ good solar access in spring, autumn, and summer only for the pocket park


/ good solar access all year-round to the central plaza

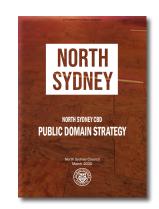

good solar access areas in spring, autumn and summer only

good solar access areas all year round

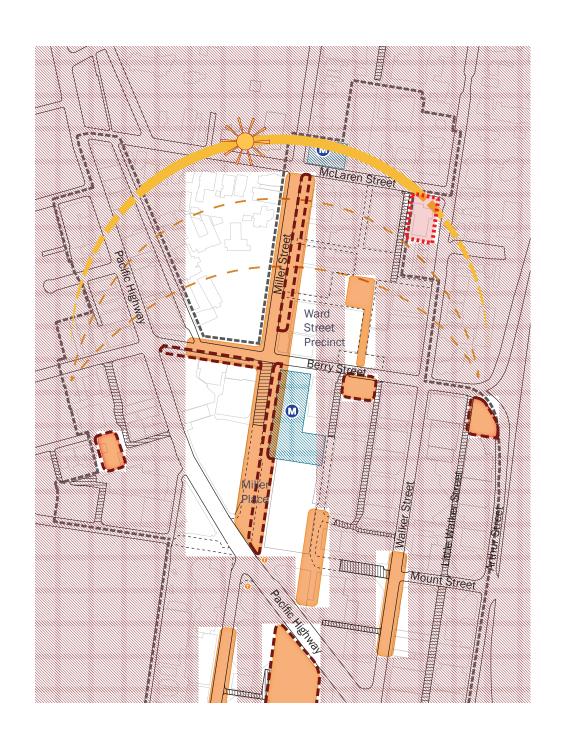

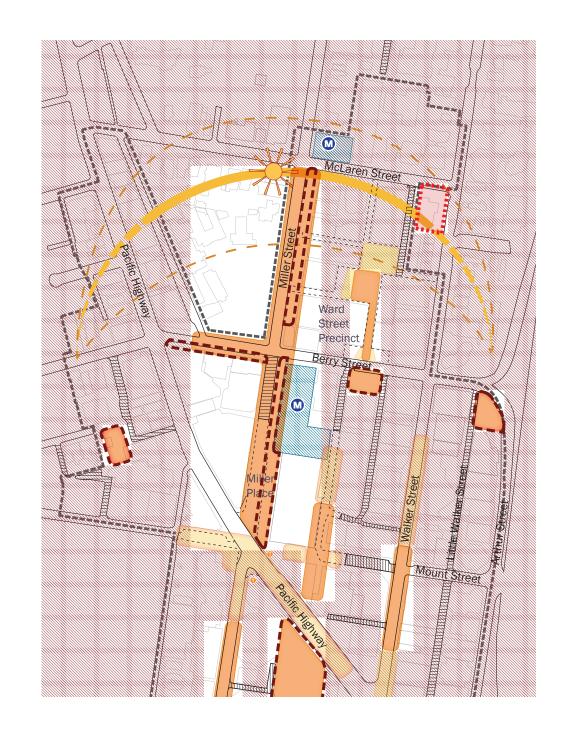



CIVIC PRECINCT STUDY


TRANSITIONAL BUILDING MASSING


The Civic Precinct is located north of the North Sydney CBD. Part of the study proposes that at the edges of the Civc Precinct are transitional zones between the CBD and the precinct, particularly along Walker and McLaren Streets. The site is located at the corner of these two streets.

These transitional zones seek to:

/ provide a height transition between the commercial core (up to 40 storeys) and the lower conservation area

/ protect the amenity and sunlight of existing and proposed public open spaces

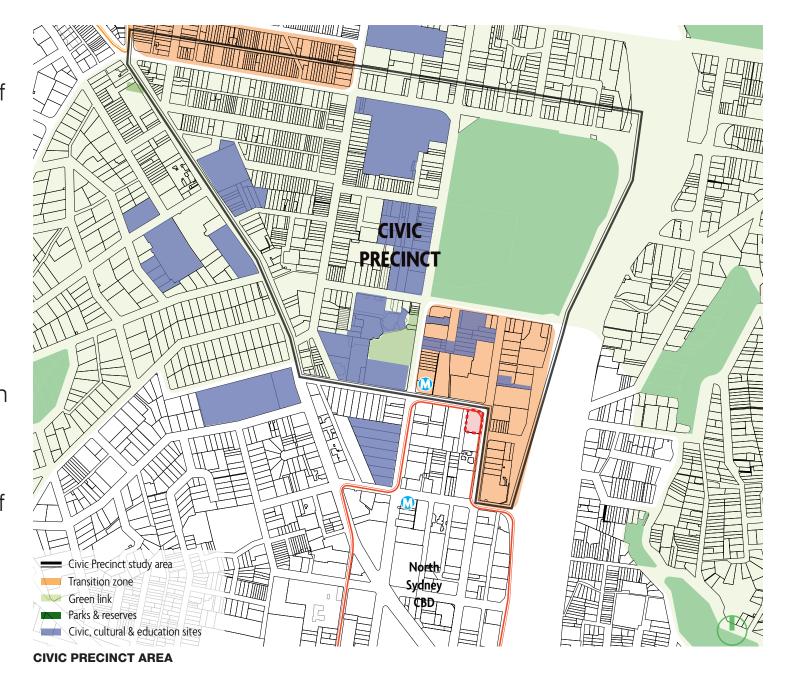

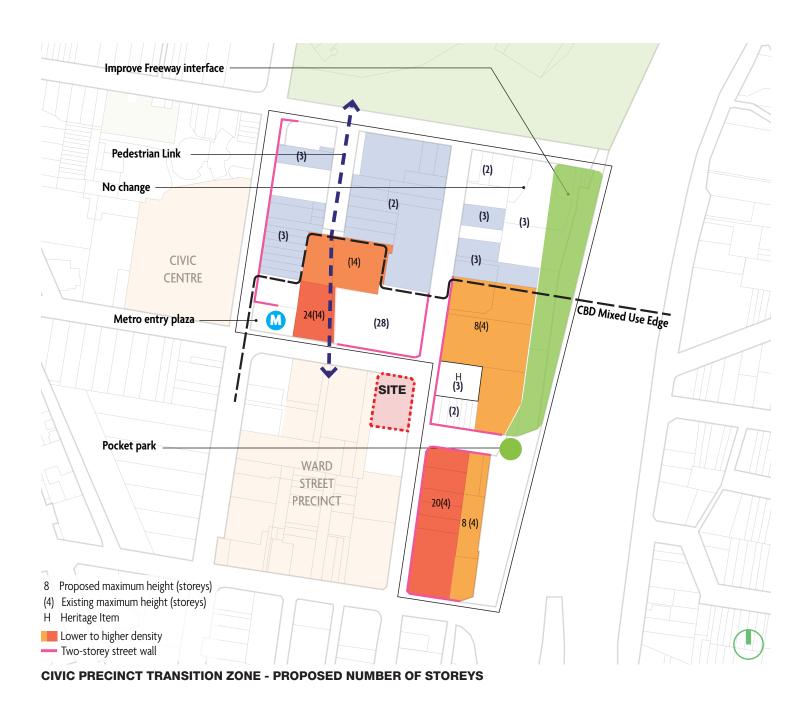

CIVIC PRECINCT STUDY

CIVIC PRECINCT IMPLEMENTATION

/ increase the southern half of 52 McLaren street


/ maintain the current height to the northern half of 52-54 McLaren st

/ rezone the current R4 zone along the east side of Walker Street to B4 and B3 zones, except for heritage listed sites, and require mixed-use towers and mid-rise standalone commercial buildings


/ increase the maximum height to 8-storeys to the area fronting the Freeway


SITE CONCEPT CONSIDERATION

The site, located at the junction of the main civic transition area, aims to build on the strategy of providing both a mixed-use building and a building that assists in the transition in height between the CBD and the Civic Precinct.

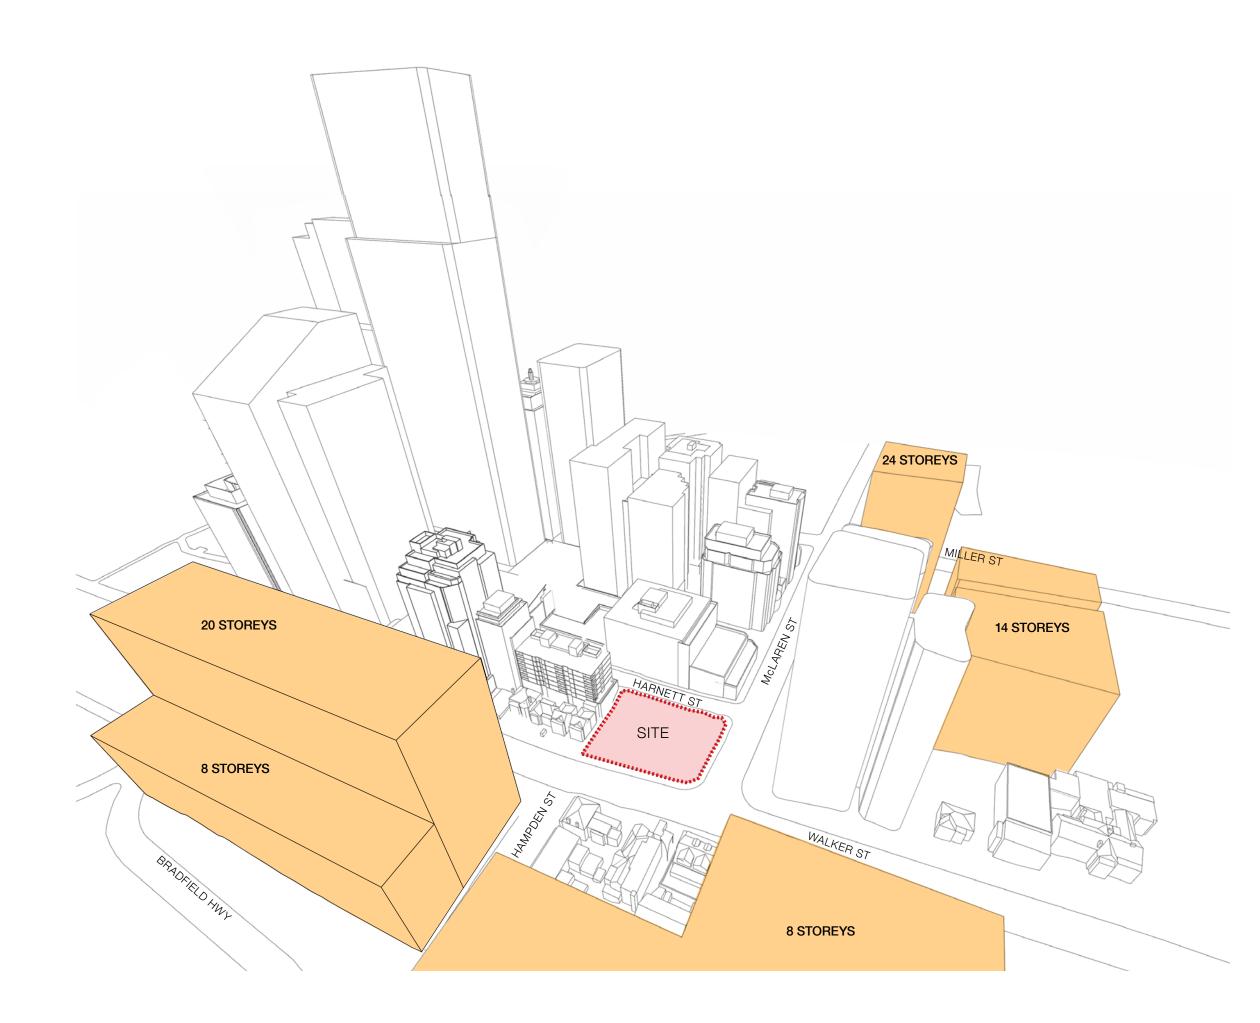


EXISTING CONTEXT

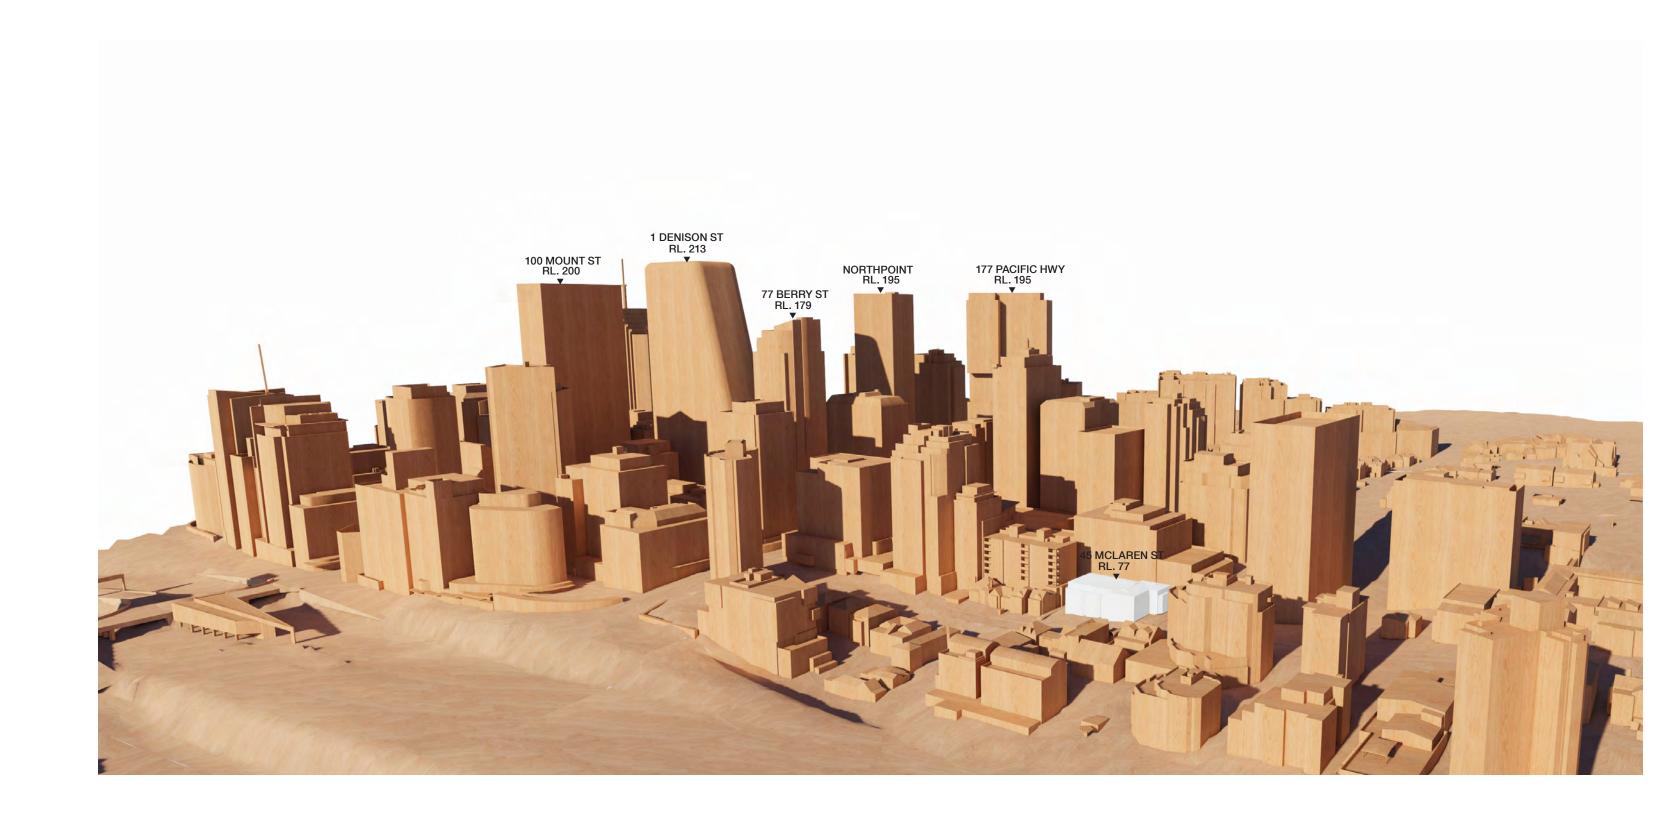

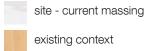



FUTURE CONTEXT

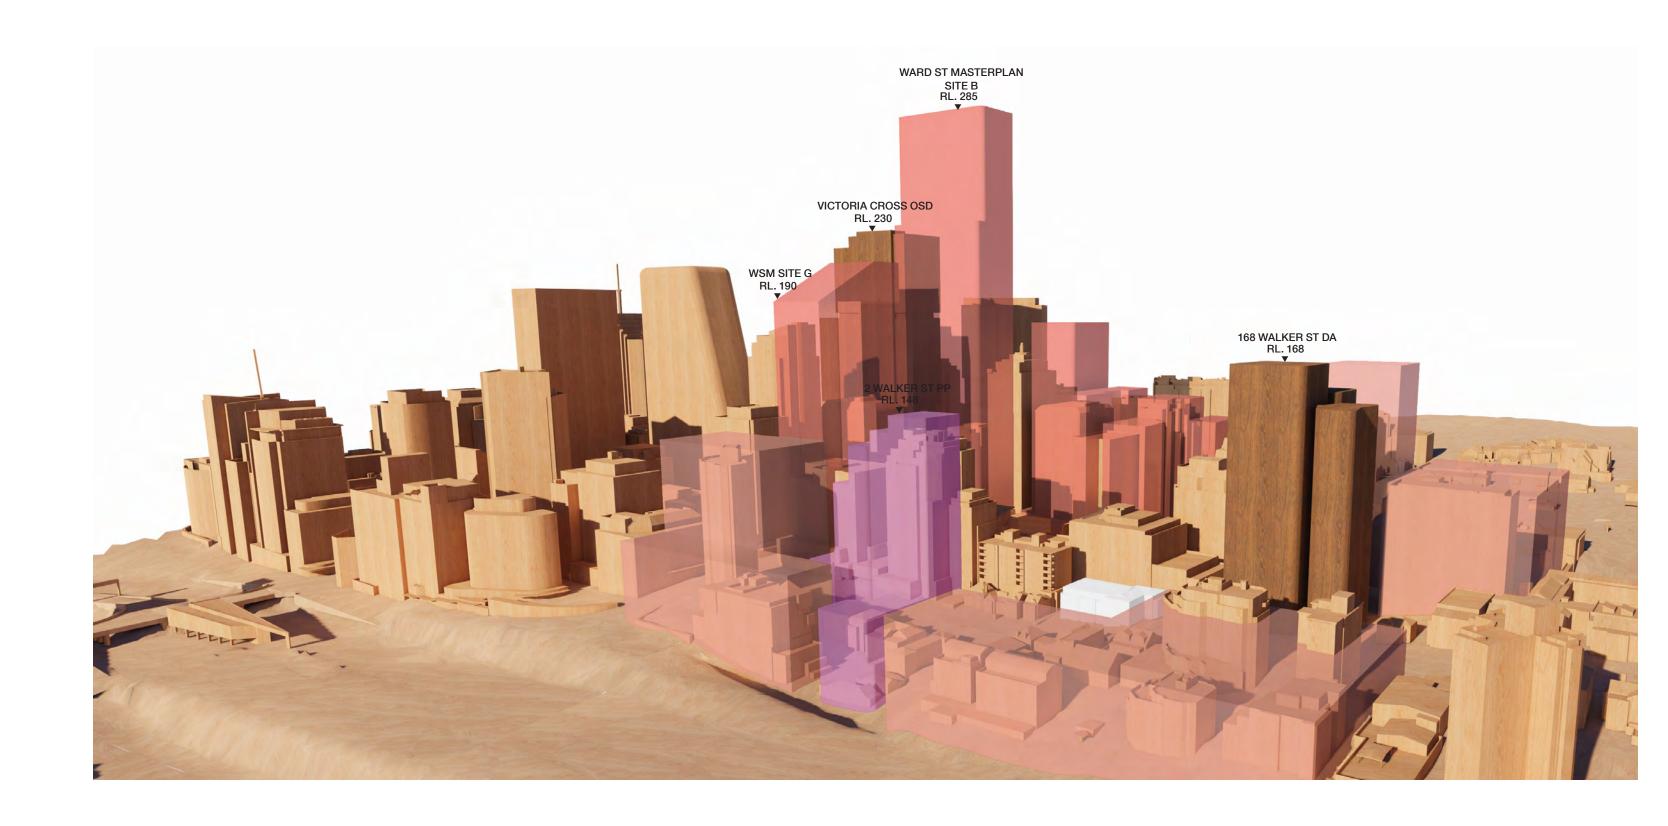








ENHANCING THE THROUGH-SITE LINK

The podium has been set back along the southern boundary in order to provide a more generous throughsite link that connects Walker Street to Harnett Street. At approximately double its existing width, the 3m wide link enhances the pedestrianisation around the site and further promotes activation of the Ward Street Plaza.

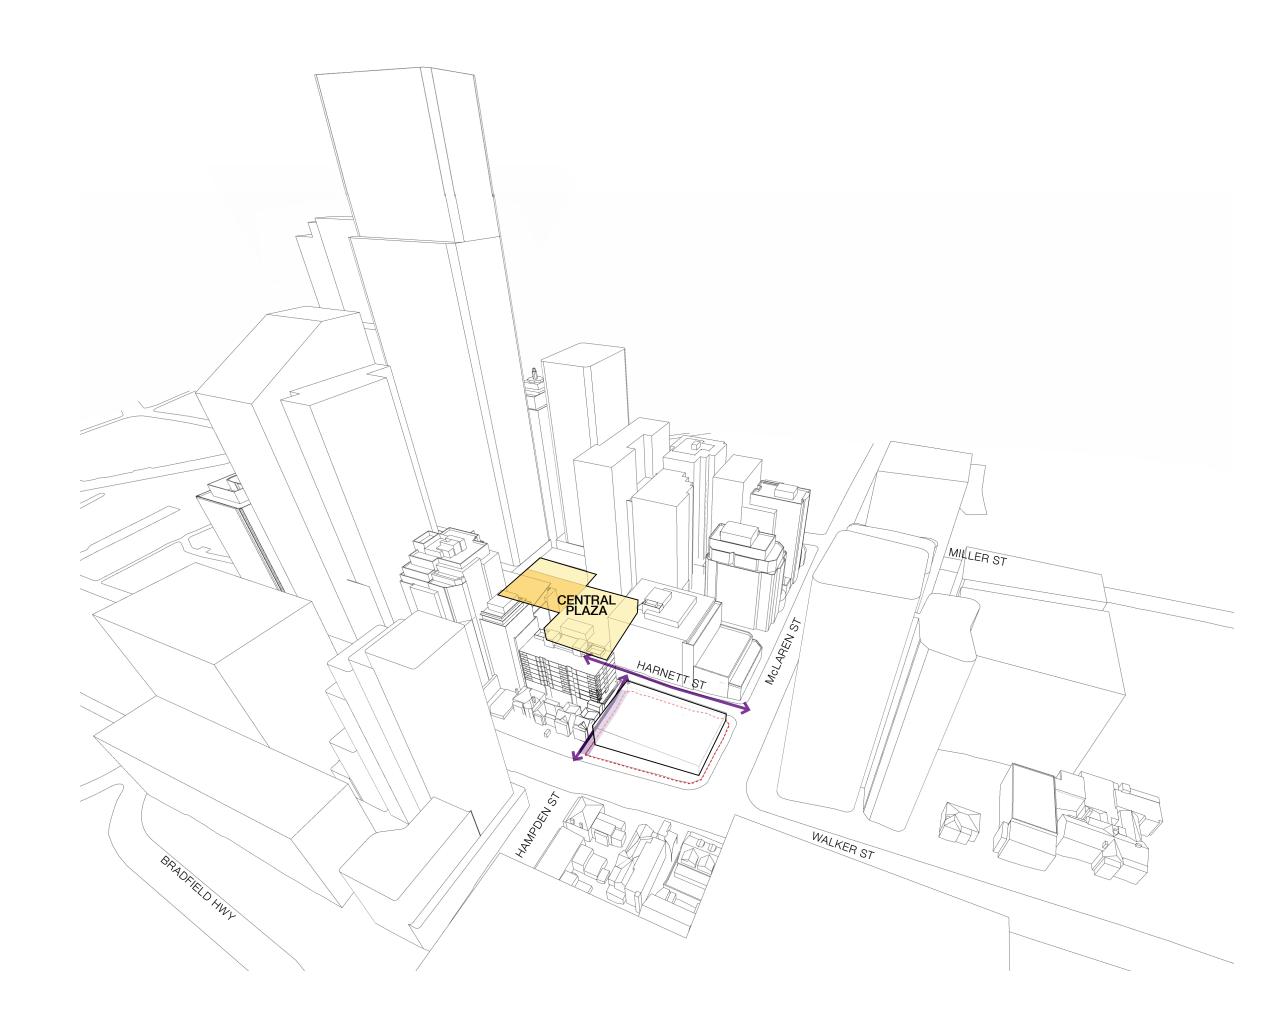


STREET ALIGNMENTS AND SETBACKS

RESPONSE TO HERITAGE

The podium fronting Walker Street has been setback to align with the heritage terraces south of the site. In front of the podium is soft landscaping, which is in keeping with the neighbouring property and the leafy character of the surrounding context.

The podium massing further aligns with 41 McLaren Street, immediately west of the site.

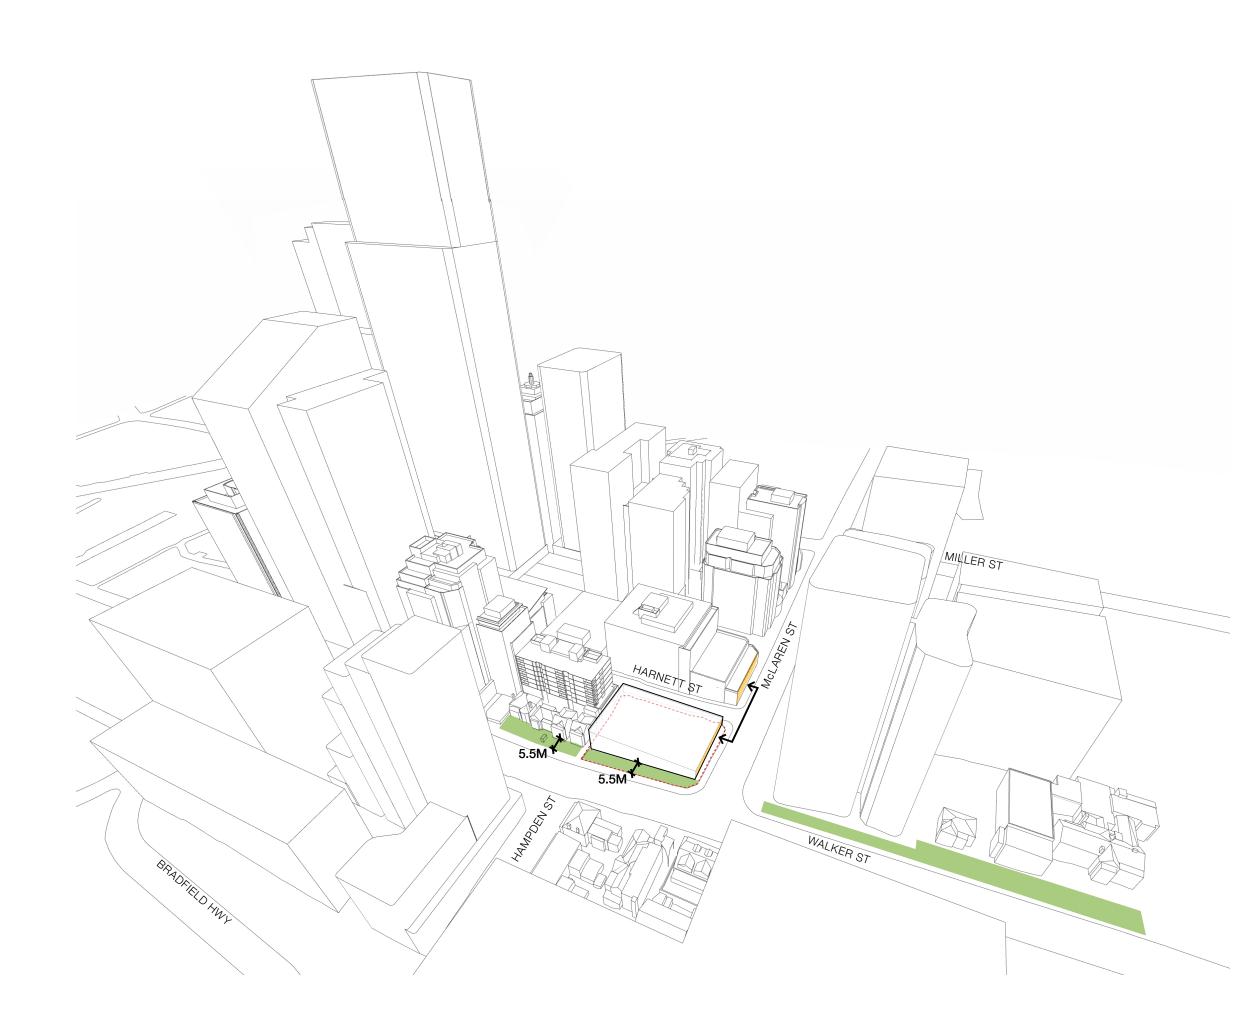


RESIDENTIAL PODIUM

RESPONSE TO HERITAGE & CONTEXT

By providing residential terraces along Walker Street, it enhances the heritage / residential context immediately south and east of the site.

The height, scale and modulation of the podium has been sculpted to provide a thoughtful urban response to the adjacent heritage context.


Similarly to the heritage buildings, the proposal sculpts individual 2-3-storey terraces fronting Walker Street, with outdoor balconies and direct street access, as a modern interpretation of the heritage context.

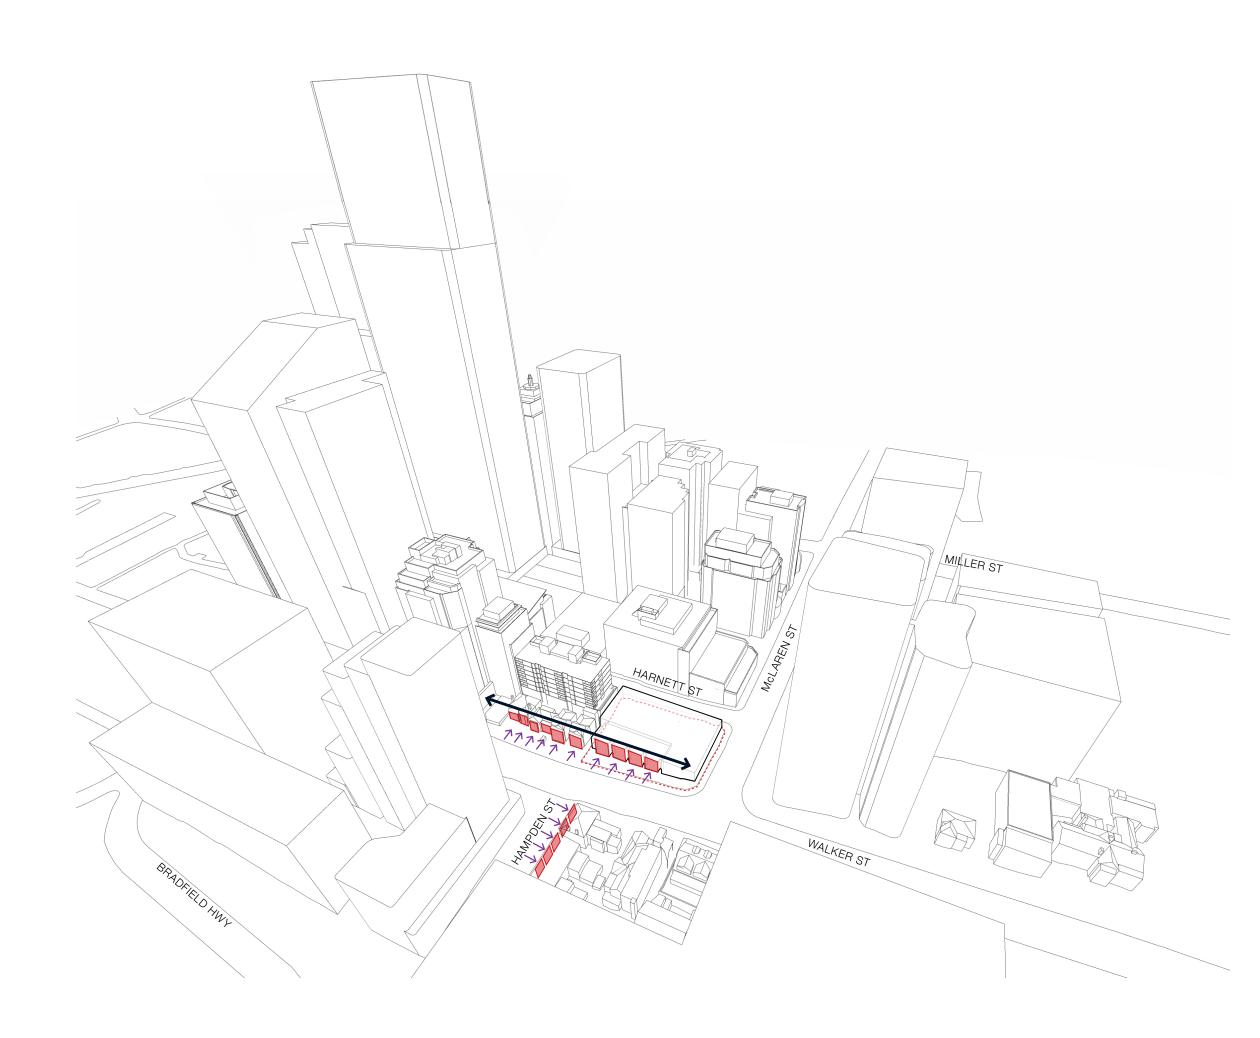

RETAIL PODIUM

RESPONSE TO HERITAGE & CONTEXT

The retail offering along McLaren and Harnett Streets responds to the heritage / commercial context immediately west of the site. The location of retail is also in keeping with the more public presence of McLaren Street / Victoria Cross Metro North.

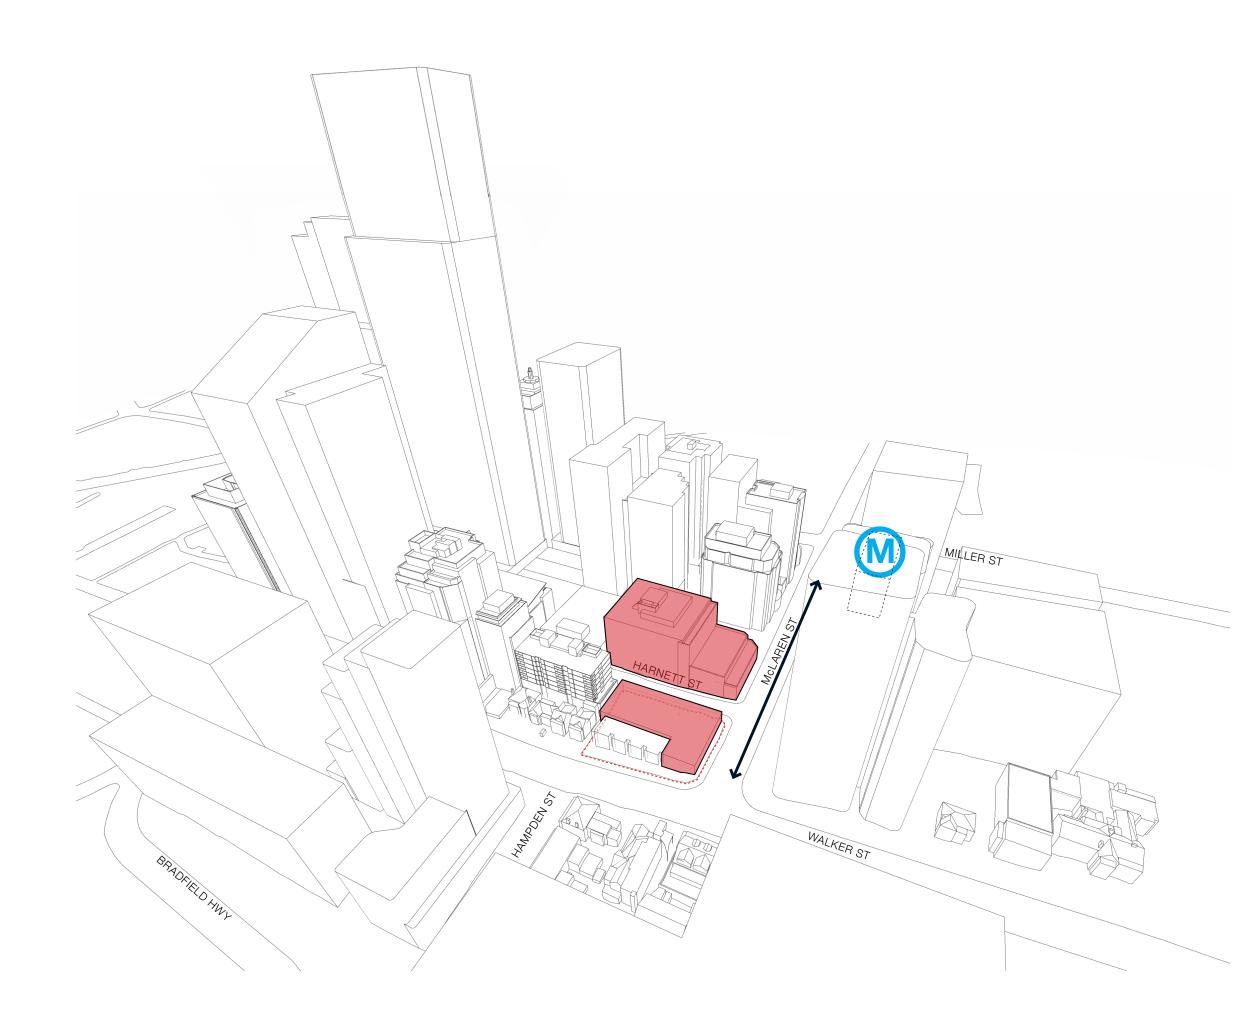

ACTIVATION & INTERFACE


The podium provides an active frontage and/or passive surveillance along all four boundaries of the site.

/ McLaren Street is activated by retail spaces and the residential lobby

/ The raised residential terraces along Walker Street provides both activation and passive surveillance

/ Three levels of retail spaces front the widened pedestrian through-site link, providing passive surveillance

/ Entry into the retail spaces has been provided along both McLaren Street and the southwest corner of Harnett Street, with the retail offering providing passive surveillance as the site slopes upwards towards McLaren Street

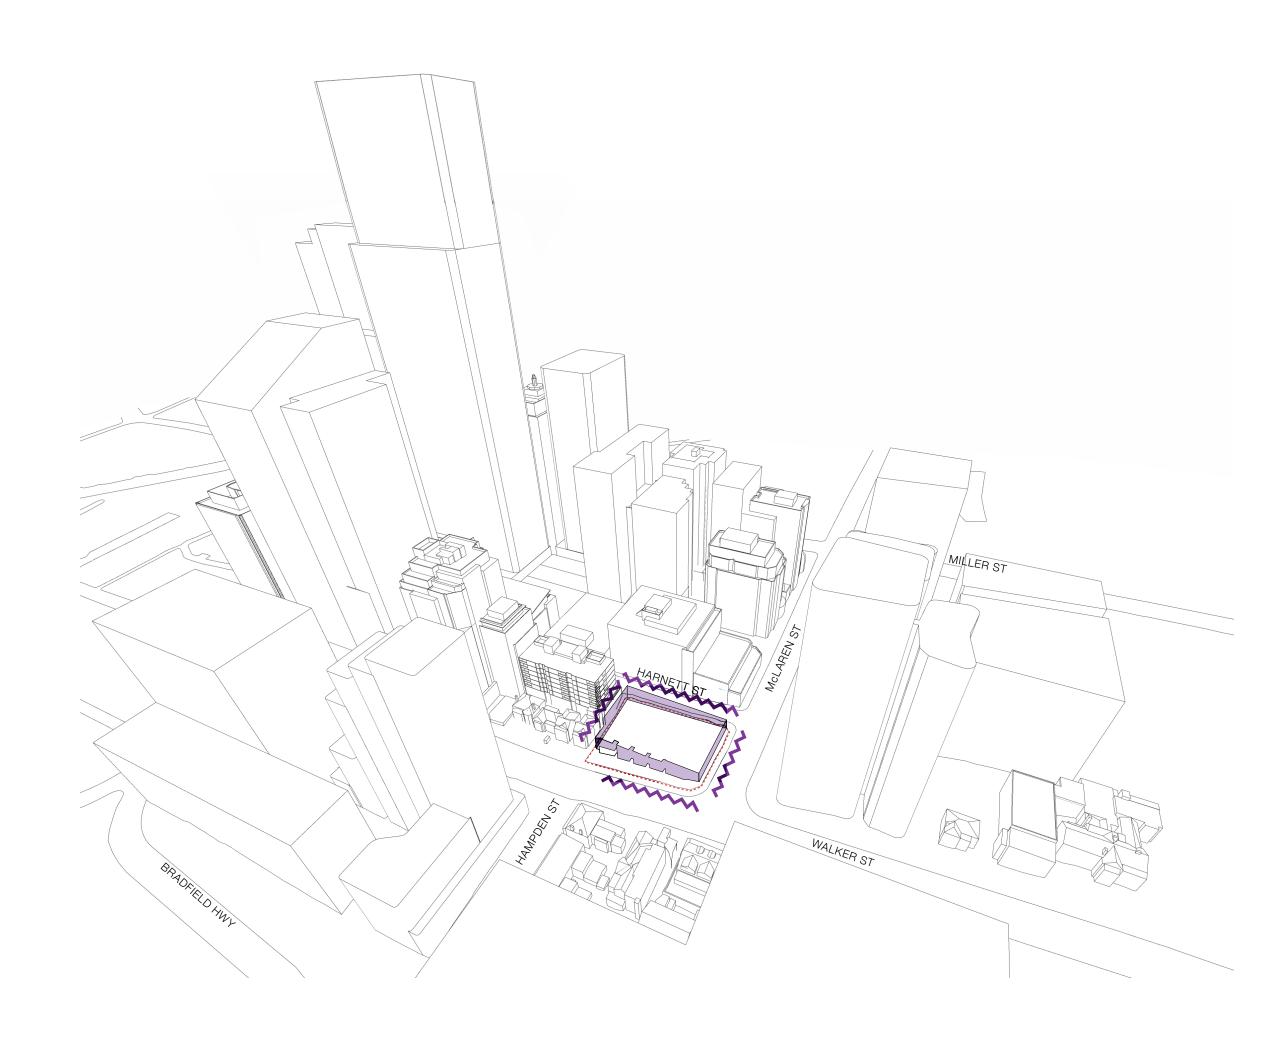



MIXED-USE PRECINCT

The proposal offers a mix of retail and residential uses. As a direct response to its surrounding context, the podium consists of residential terraces along Walker Street, and retail along McLaren Street.

The mid-rise tower to the building is set back from the podium, and is dedicated for residential use.

The proposal is then in-keeping with the objectives of the Ward Street masterplan.

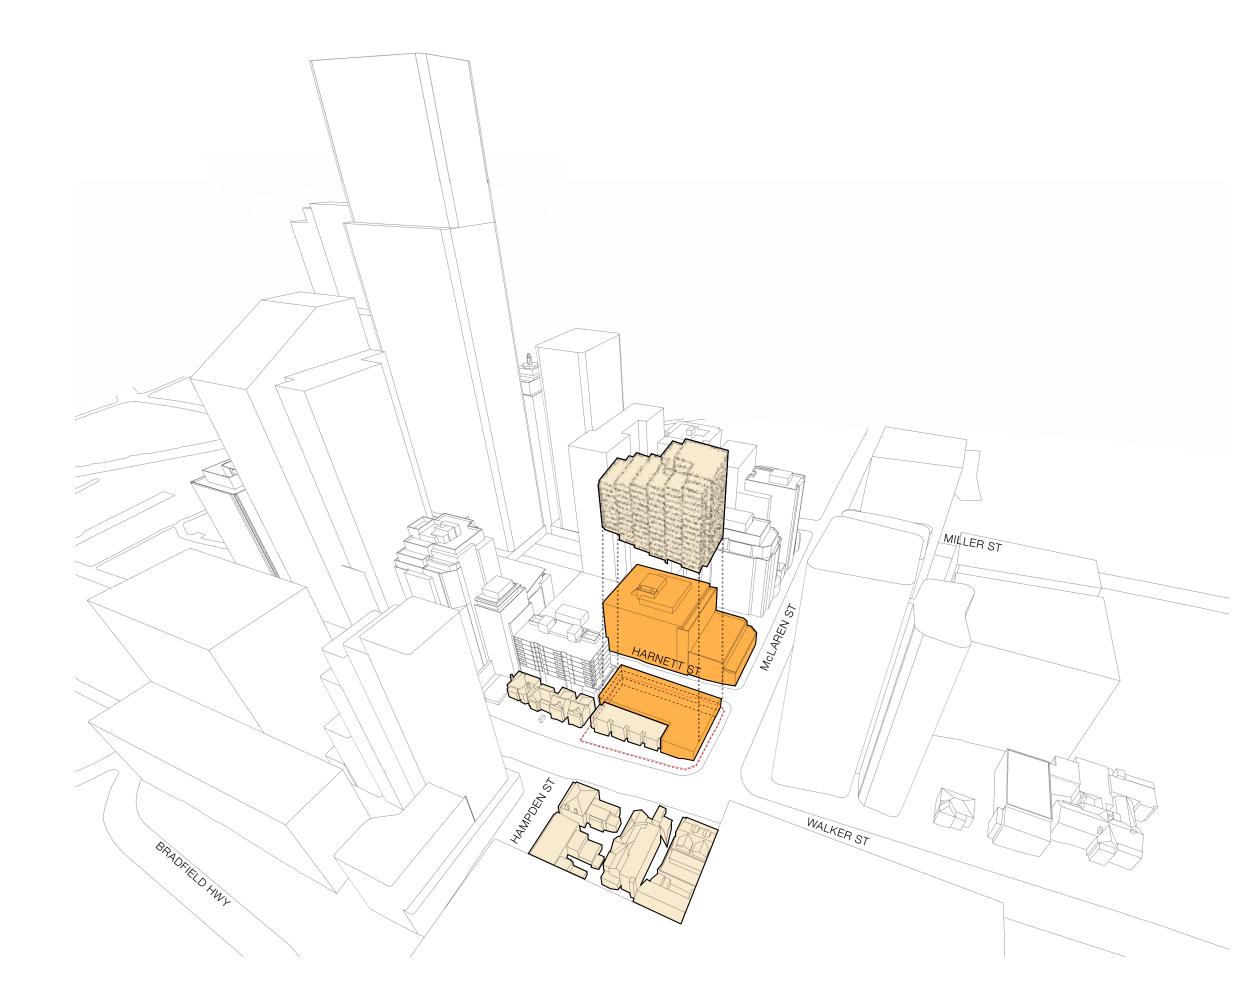

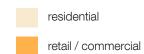




TOWER SETBACK STEPPING & ALIGNMENTS

In keeping with the series of stepped vertical massing arrangements that occurs south of the site, with no consistent tower setback, the proposal provides a stepped transition between 168 Walker Street and 150 Walker Street apartments, which is set back 5m and 20m respectively.

In addition, the proposal maintains the consistent tower street alignment that runs along McLaren Street.



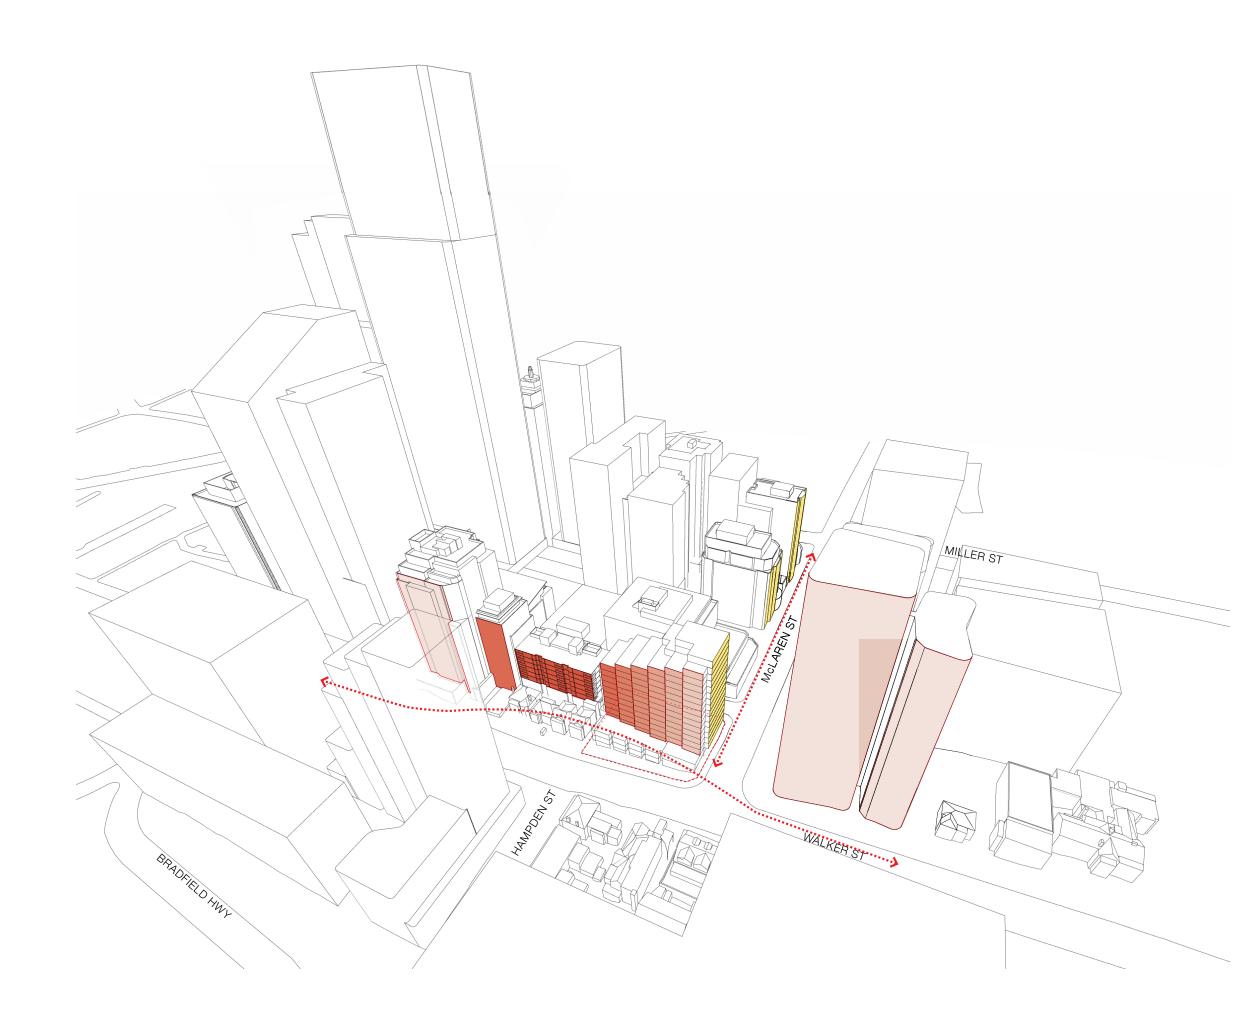


TOWER STEPPING SOLAR ACCESS

Working with the solar plane cast by 168 Walker Street, the tower steps to meet this solar plane, and provides a massing transition between 150 Walker Street Apartments and the residential tower to 168 Walker Street. This has been undertaken to simultaneously achieve the following:

/ maintain solar access to the neighbouring property, 150 Walker Street


/ provide solar access to the proposal

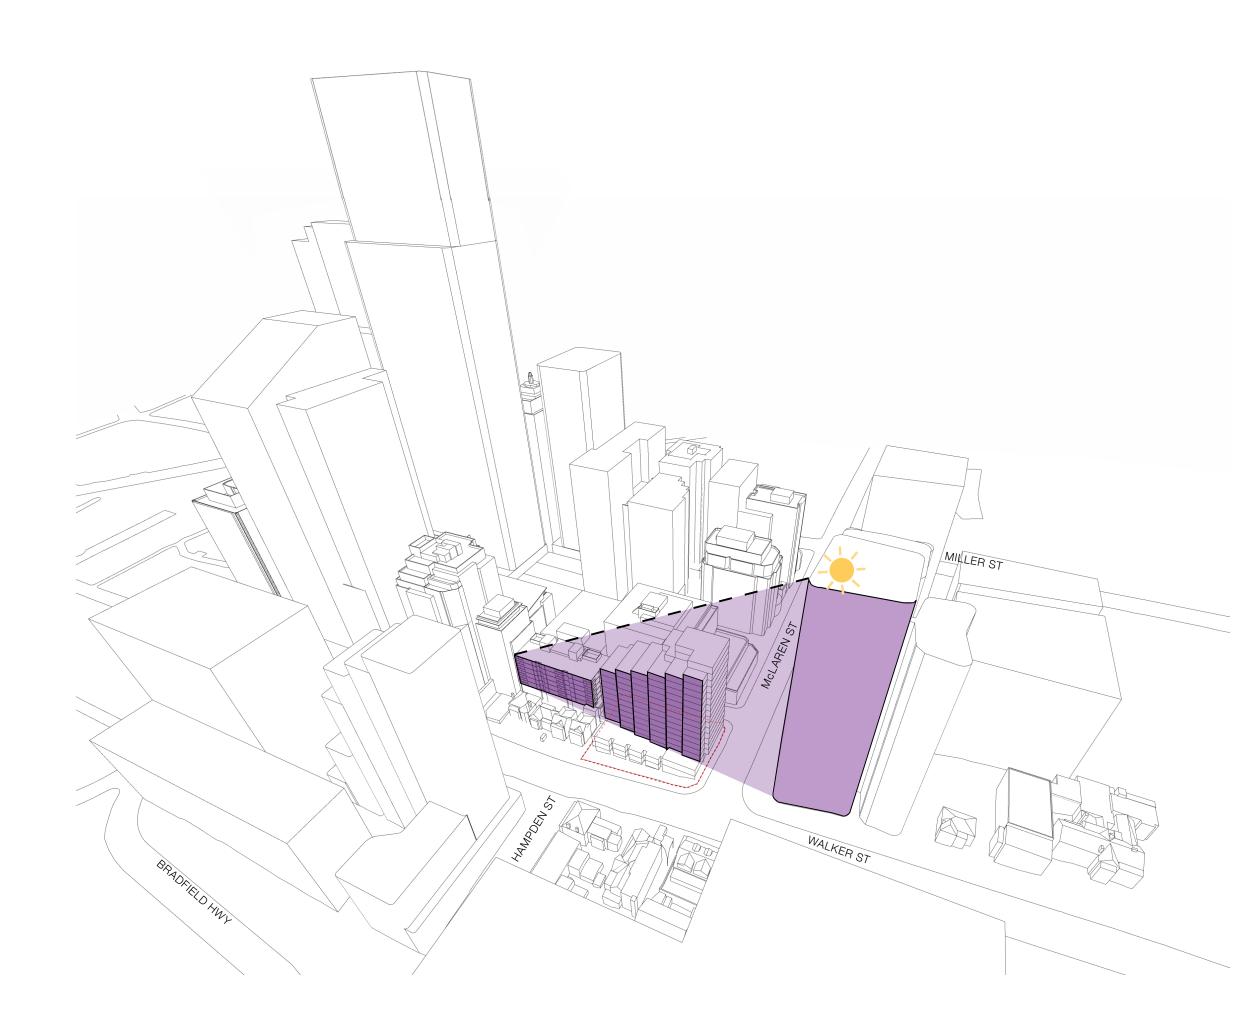

BUILDING HEIGHT TRANSITION & DATUM

The proposal provides a transition in tower heights from the D.A. approved 28 storey tall tower at 168 Walker Street, located at the corner of Walker Street and McLaren Street, and the residential apartments located at the rear of 150 Walker Street.


The podium further provides a consistent low-scale datum, which is consistent with the heritage buildings located south and east of the site.

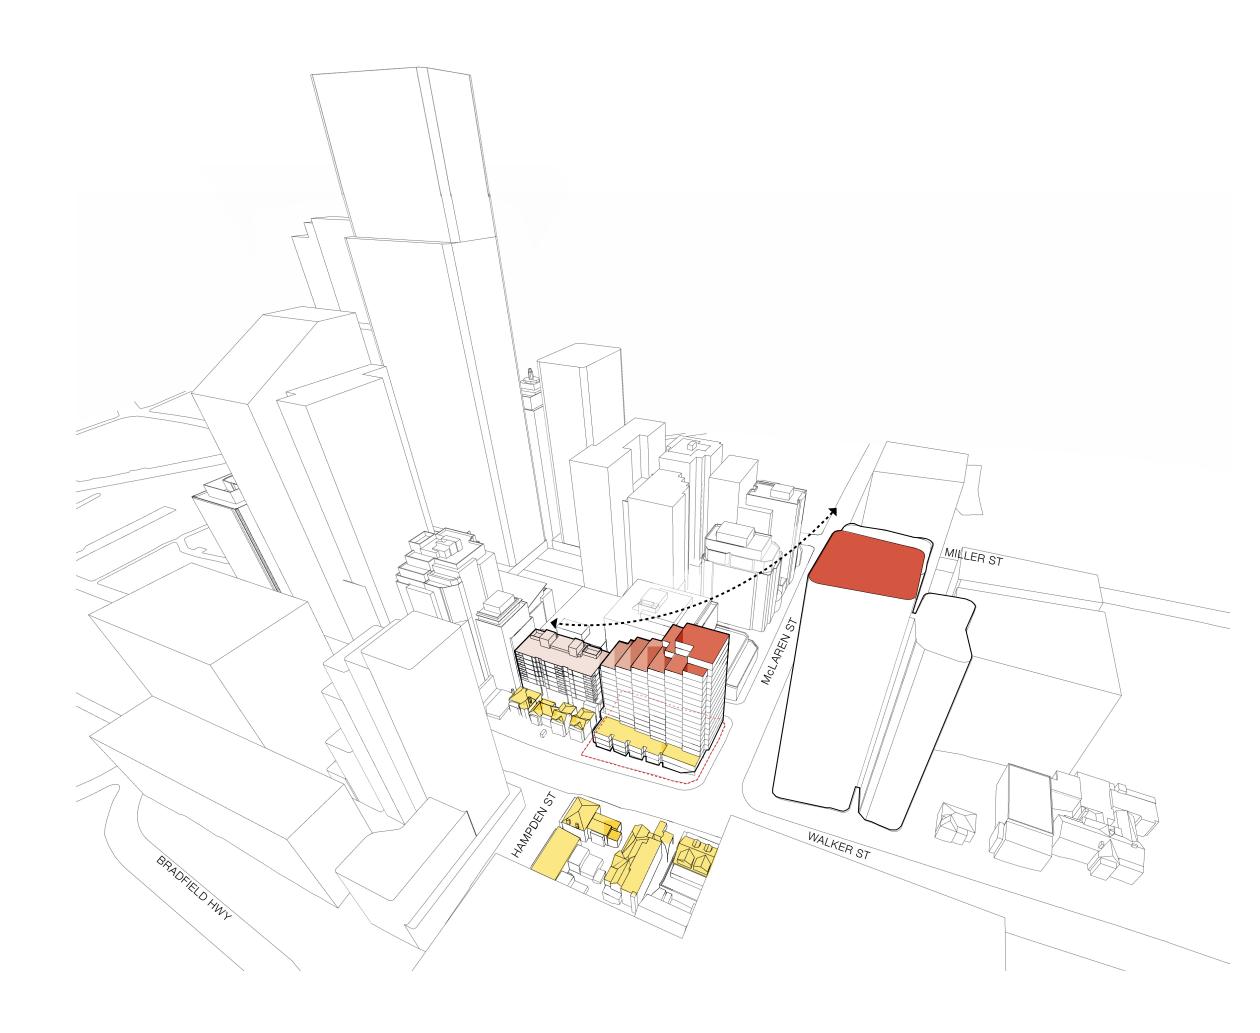

ROOFTOP STEPPING

SOLAR AMENITY TO PLAZA

The stepped rooftop massing seeks to maintain good solar access to the Central Plaza, which is in line with the strategies of the Ward Street Masterplan.

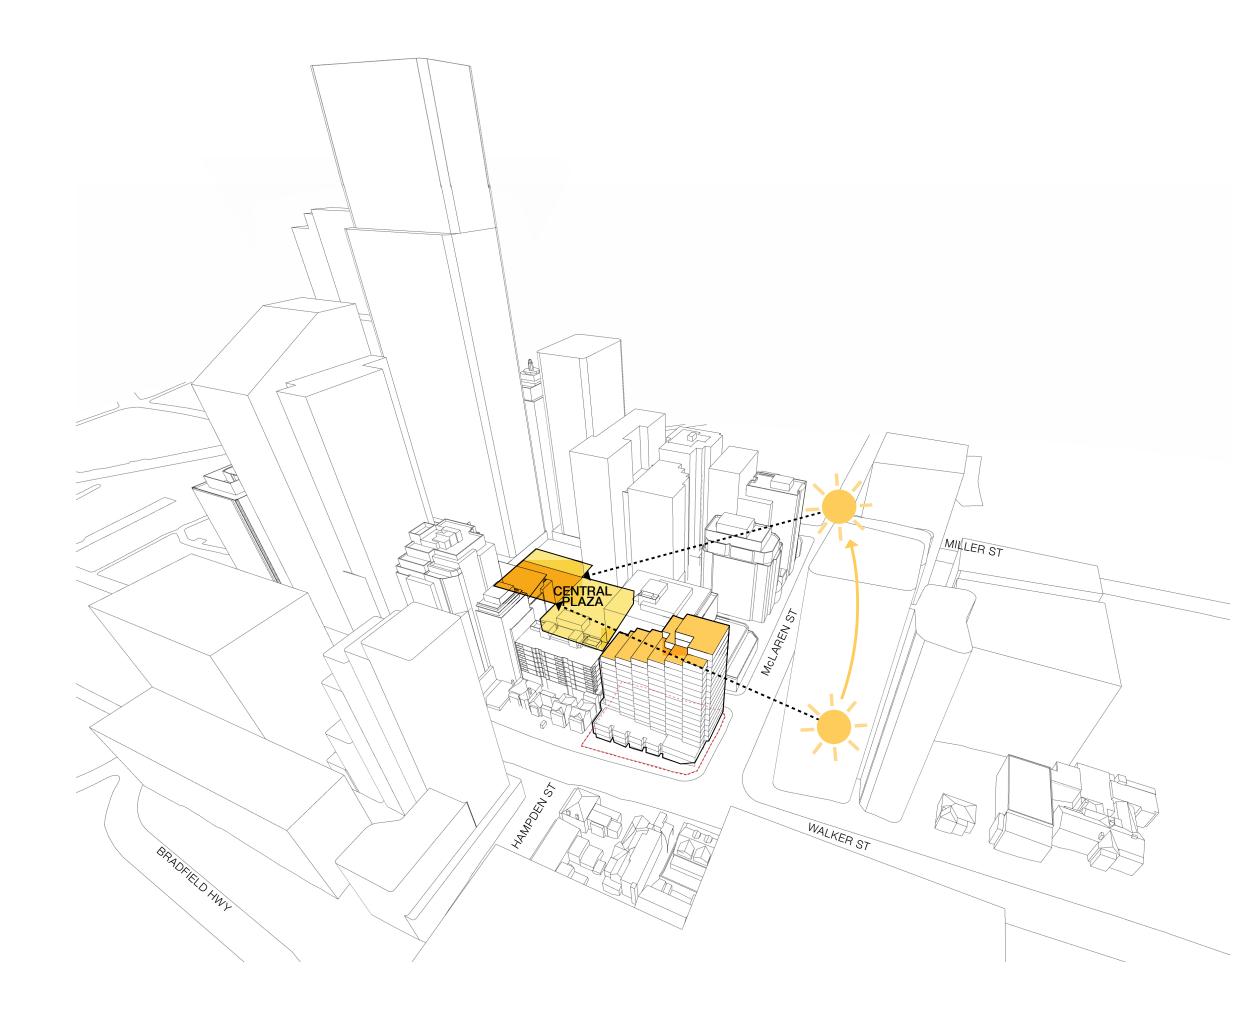


LANDSCAPE TERRACING

The design provides an abundance of landscaping opportunities thorughout the site.

/ The podium has been set back along Walker Street, creating a green leafy strip

/ The residential building is set back from the podium, which provides the opportunity for landscaped rooftops above the podium terraces

/ The stepped and staggered rooftops to the top of the building further enables a series of private and communal landscaped terraces

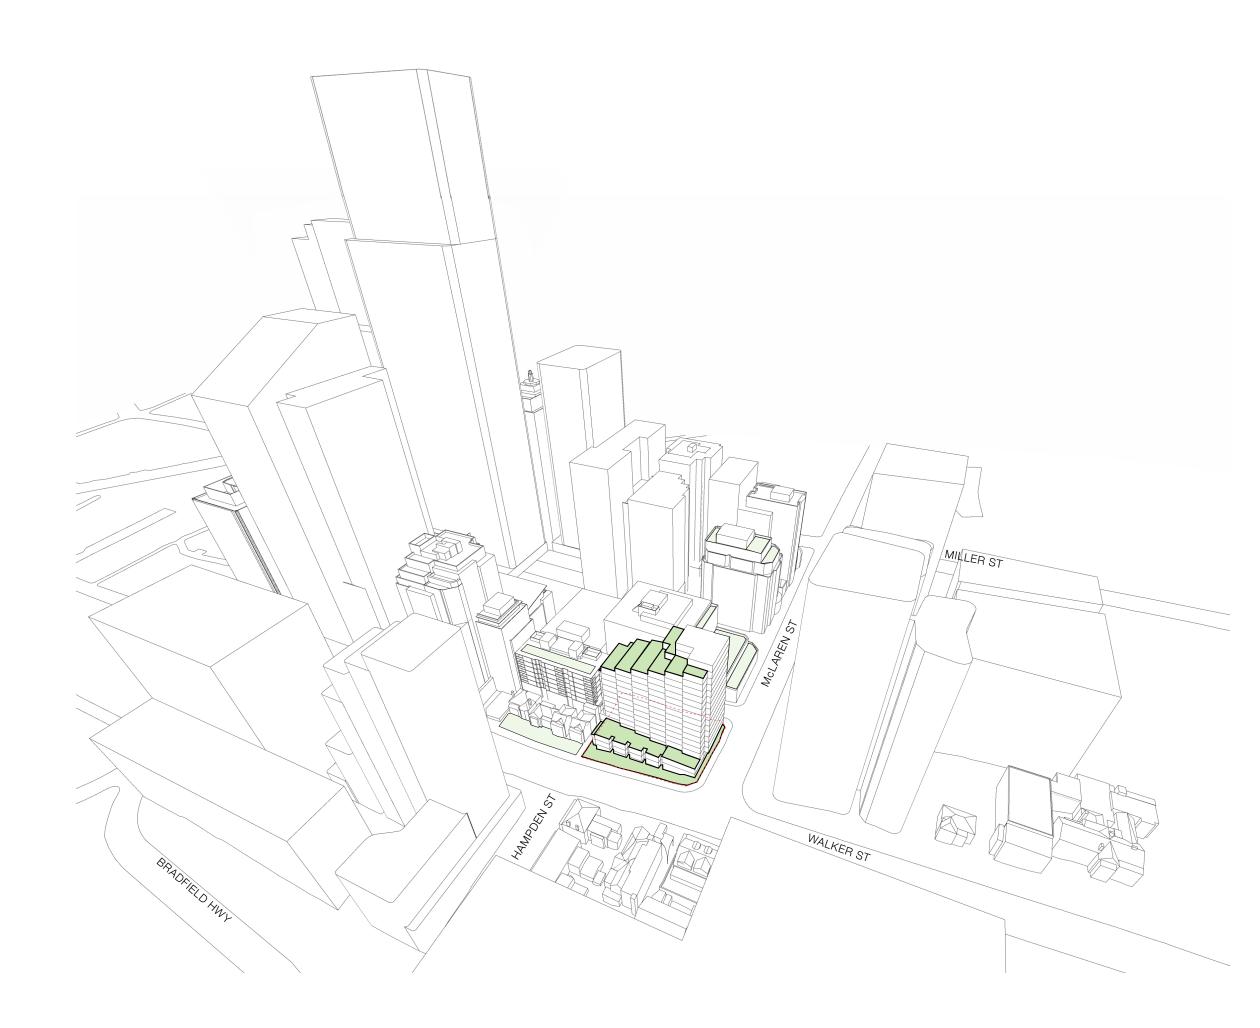

BUILT FORM ESD PRINCIPLES



CONTEXT

Shaped to mediate urban scales responding to the city built form



ORIENTATION & POSITION

Designed to increase daylight to surroundings and limit overshadowing



GEOMETRY

Designed to optimise orientation and reduced heat load to west, maximise north and east aspect



EQUITY

Design of building massing to maximise solar access to adjacent developments and the public




VIEWS


maximise daylighting hours and views received by building users. Privacy can be addressed by the generous spacing of building blocks and far ranging views.





SOLAR ACCESS


Maximisation of solar access through considered building orientation

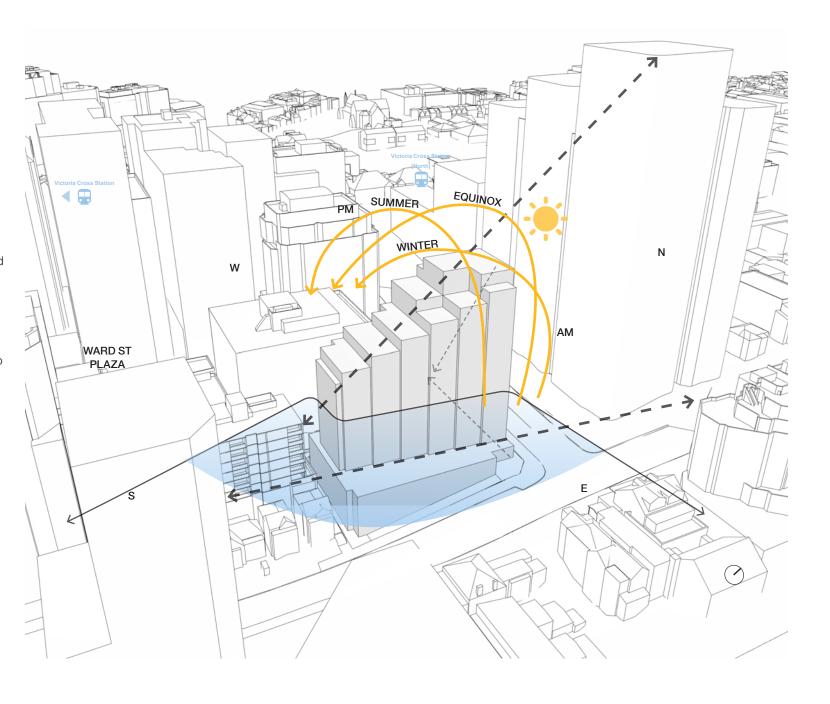

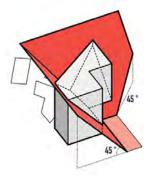

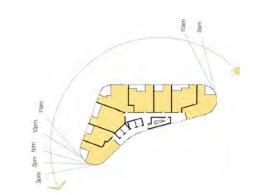

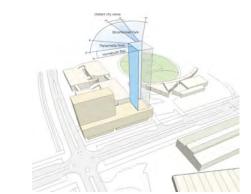

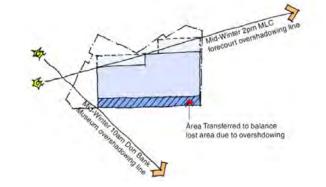







PASSIVE DESIGN ESD PRINCIPLES



DAYLIGHT

Optimising daylighting levels for healthy internal environments and enhanced indoor-outdoor connections.



GREYWATER USE

Uses include water for toilet flushing, irrigation of plants and recycled heat for hot water



RAINWATER COLLECTION AND REUSE

Capture the flow of rainwater from roof gutters to a rainwater storage tank and subsequent treatment and reuse.



AIR & NATURAL VENTILATION

Maximise natural & cross-ventilation opportunities.

Optimising ventilation oppurtunities for healthy internal environments and enhanced indoor-outdoor connection



GREEN SPACE

Insulated Green Roof reducing Heat Gain, thermal mass and the Urban Heat Island Effect.



COMMUNAL SPACE

balconies & wintergardens create buffer zones




HIGH PERFORMANCE BUILDING ENVELOPE

Designing high performance, well-insulated and thermally broken building envelopes. Balance between glazing to achieve daylight and views and solidity to improve thermal performance



AIR TIGHT FACADES

Passive House rated building Envelope, Detailed to be well insulated, thermally broken and well sealed

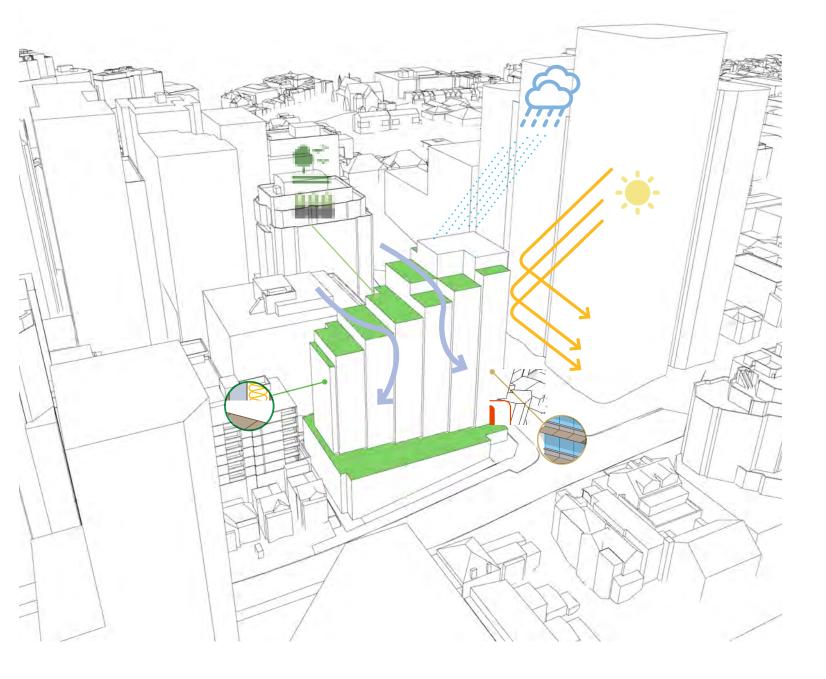












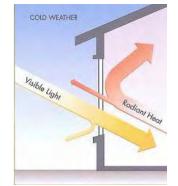

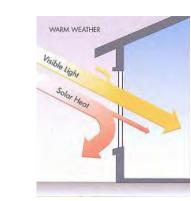

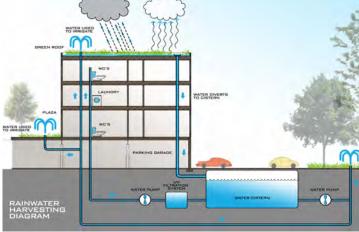



OPTIMISATION ESD PRINCIPLES



NET ZERO EMISSIONS

All electric systems (remove all fossil fuel usage) and onsite renewable energy generation & procurement. Residual Energy offset. An embedded network with obligation for renewable energy.



On-site renewable distribution Implementation

- 1. improve energy efficiency through design reduce energy consumption/ optimise/ produce
- 2. procure Renewable Energy
- 3. purchase offsets



SOLAR GENERATOR

Use of smart embedded network linking Photovoltaic cells embedded onto roofs generating energy where roof space is not being used for gardens



EFFICIENT FIXTURES & SYSTEMS

Use of efficient fixtures such as vacuum flush toilets, foam flush toilets and urinals or compost toilets



HIGH PERFORMANCE HVAC - ALL ELECTRIC, EVAPORATIVE COOLING


High level of BMS control


maximising energy saving with optimised thermal zoning with temperature control, efficient lighting design, mixed mode air handling, High energy efficient low temperature VAV Systems and water+ energy metering.





SMART ENERGY USE

Thermal storage to maximise reuse of waste heat; Induction appliances; Heat pumps for Domestic Hot Water & Space Heating. Battery storage as part of embedded network. Car Stacker with power source for charging electric vehicles.

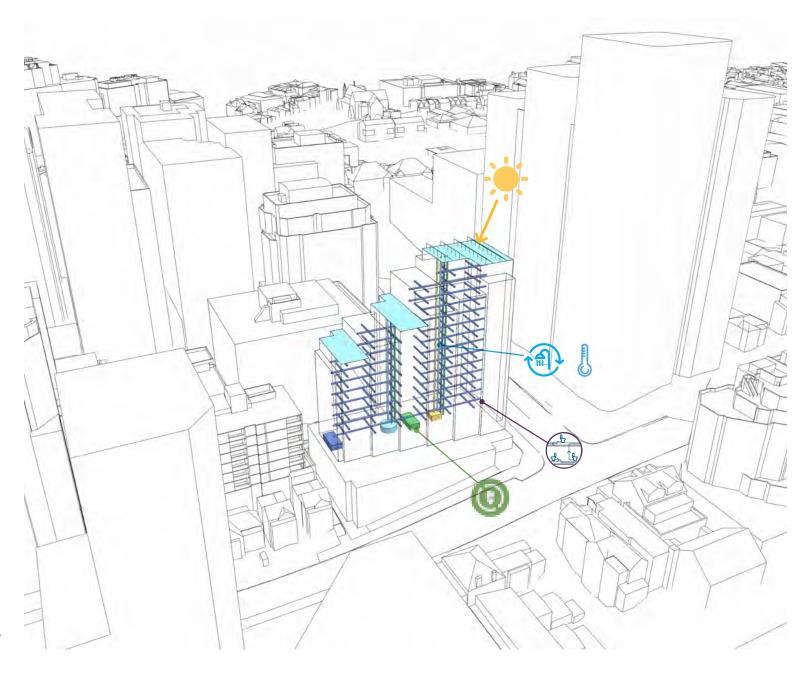

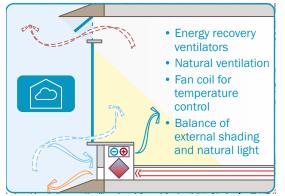

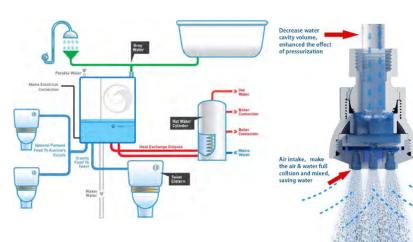

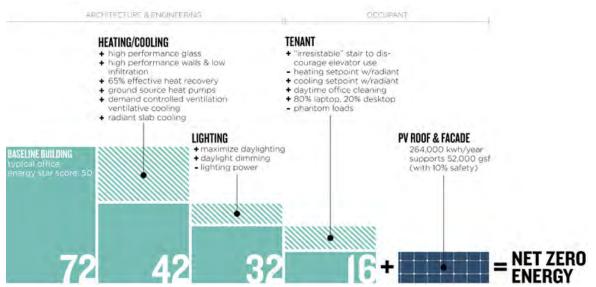





EMBODIED CARBON



SOURCING & CHOOSING MATERIALS

Selection of low embodied carbon materials an construction methods Incorporating place-based solutions that contribute to the expansion of a regional economy rooted in sustainable practices, products, and services



RECYCLED MATERIALS

Circular economy Low embodied energy and high recycled content



EMBODIED CARBON

Selection of low embodied carbon materials with consideration for material durability and ongoing mainteenance schedules



OPERATIONAL WASTE & MATERIALS MANAGEMENT



LOW EMBODIED CARBON STRUCTURES

Certified timber products Low embodied energy and high recycled content. Low-carbon concrete




RESPONSIBLE INDUSTRY

Utilising third-party certification standards providing information on material content, sustainable resource extraction and fair labor practices




MATERIAL DURABILITY AND MAINTENANCE

Durable finishes with Low VOC and formaldehyde finishes &Ozone depletion free refrigerants GECA certified internal finishes

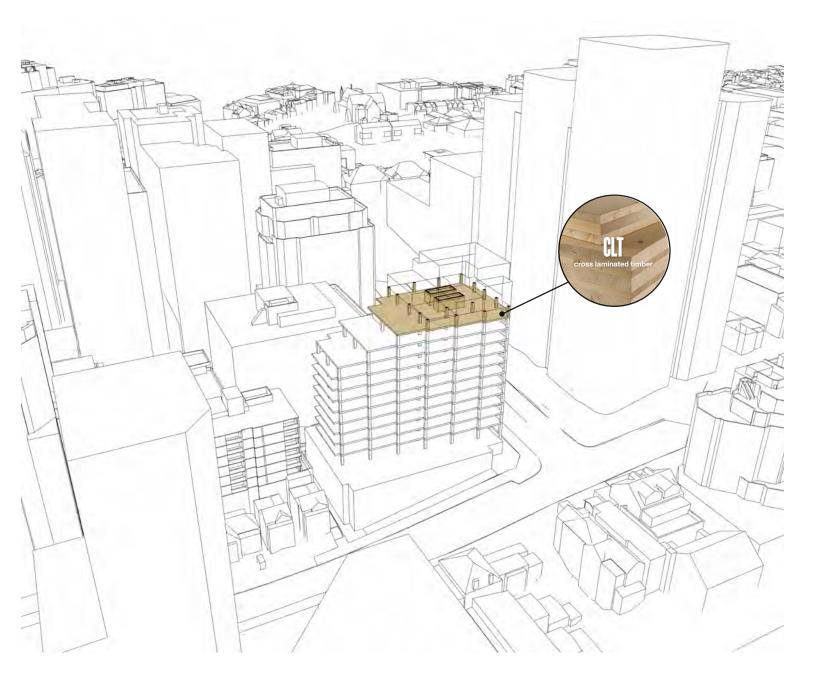



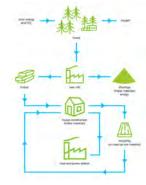











32MPa 50% fly-ash on

25% recycled bondek.

227



CLT (austrian) with 70mm

(S32) MPa concrete screed

283



32 MPa on formply.





Composite steel frame

200mm thick 32 MPa slabs

on Bondek

317





418

Pre-cast concrete structure with 32MPa

331

CLT (Austrian) with 150mm cement core access floor system

294

Embodied Carbon (kg CO2 / m2 NFA)


200mm post-tensioned 32

MPa on bondek.

312



PROPOSED CONTEXT

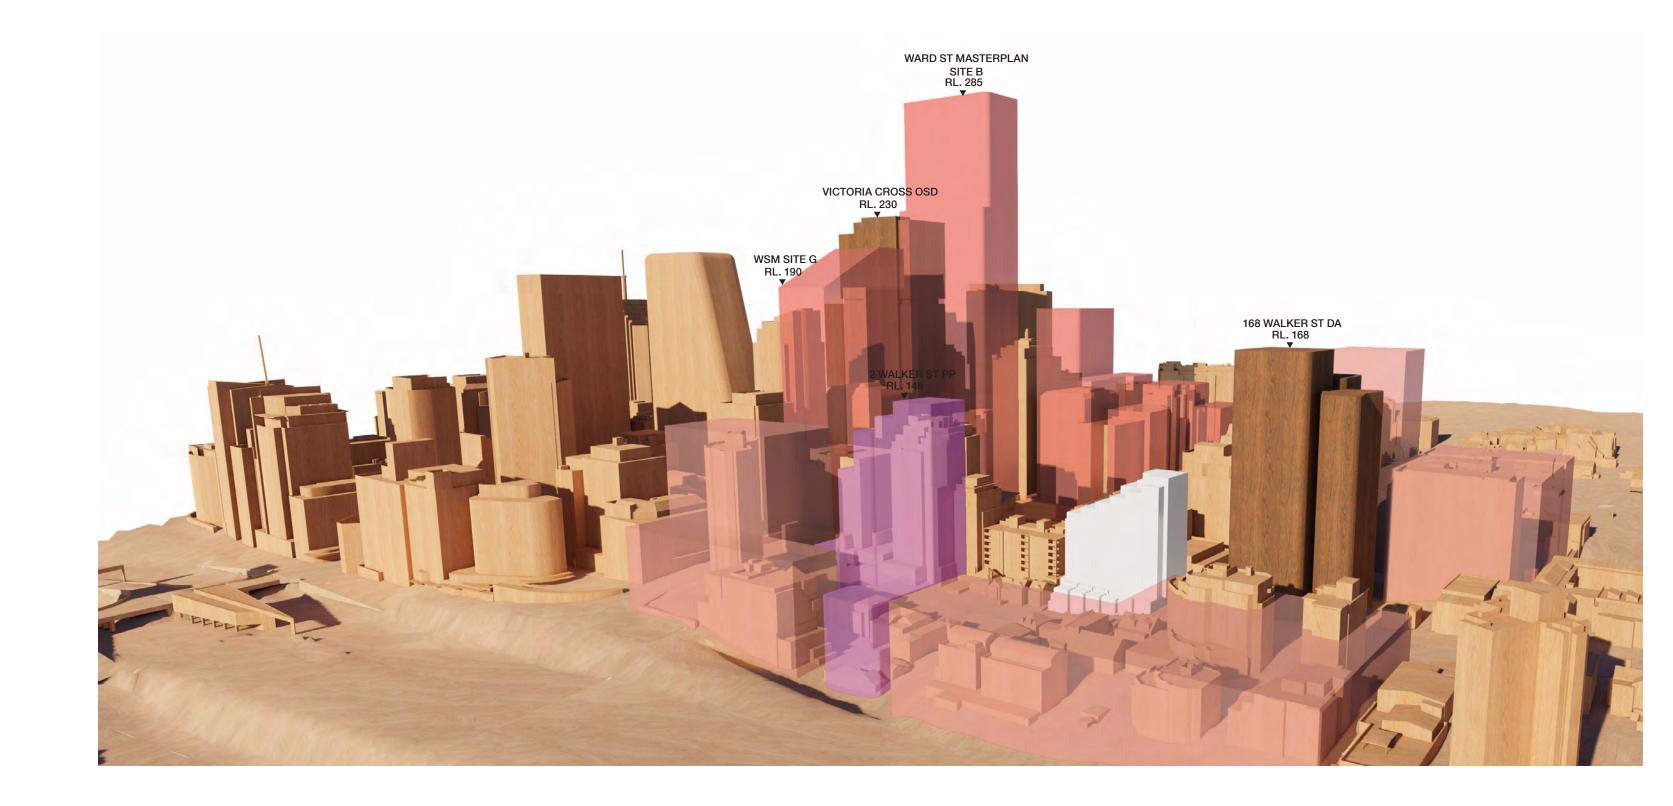

existing context

approved DA

ward street masterplan

civic precinct study

site - proposed massing

BATESSMART

planning proposal - gateway determined

CONSISTENCY WITH WARD STREET MASTERPLAN

The central objective of the WSMP is to maximise the direct public benefit in the form of public open space and community facilities whilst delivering on the North District's Plan (NDP) ambitious job targets.

The planning proposal (PP) incorporates 2.5 levels of commercial/retail floor space and the provision of an enhanced through-site link and active frontages, which is consistent with this objective.

The conceptual PP is consistent with the following Place Principles of the Final WSMP:

- 1. integration with the metro: built form that responds to the emerging context whilst providing increased density to take advantage of existing and planned infrastructure
- 2. complete the pedestrian core: enhanced through-site linkage which connects pedestrians from the eastern side of Walker Street to the new central plaza and through to Miller Street

- 3. enhance the public space journey: through the provision of active retail frontage and improved pedestrian link which supports a walkable, vibrant and connected centre
- 4. strengthen the commercial centre: new commercial/retail floor space providing for active ground floor commercial/retail uses to further support employment and the night-time vibrancy of the centre.

The composition of land uses is consistent with WSMP Option 1, being a retail podium with residential tower above.

The conceptual building envelope includes a low-rise tower (2-3 storeys) and a midrise tower (8 storeys) which is consistent with the intended development potential for the site. The additional stepped building height is capable of being accommodated with the solar access plane.

central objective



maximise direct public benefit through public open space and community facilities

2.5 levels of commercial/retail floor space and the provision of an enhanced through-site link and active frontages



deliver North District's Plan (NDP) job targets

2.5 levels of commercial/retail floor space and the provision of an enhanced through-site link and active frontages





land composition

retail podium with residential tower above



building envelope & development potential

conceptual building envelope includes a low-rise tower (2-3 storeys) and a midrise tower (8 storeys). The additional stepped building height is capable of being accommodated with the solar access plane

place principle



integration with metro

provide increased density as a response to existing and planned infrastructure




complete the pedestrian core

enhanced through-site linkage which connects pedestrians from the eastern side of Walker Street to the new central plaza and through to Miller Street



enhance the public space journey

provision of active retail frontage and improved pedestrian link which supports a walkable, vibrant and connected centre

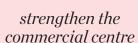

new commercial/retail floor space providing for active ground floor commercial/retail uses to further support employment and the night-time vibrancy of the centre



CONSISTENCY WITH THE DRAFT CIVIC PRECINCT STUDY

Whilst the site sits outside of the Study boundary, the site interfaces with land included in the study boundary and hence the concept has had consideration of the draft Study and its desired urban outcomes

The Stage 2 Consultation for the Civic Study identified the site as being suitable for high-rise (14+ storeys)

The study identifies 9 key actions. The PP concept scheme is consistent with the following key actions:

- 1. create more jobs and housing opportunities near the Metro
- 2. support small to medium sized business growth
- 3. preserve heritage; add value
- 4. identify access and active transport network improvements

The building envelope responds to the general design principles and design guidelines for significant sites of which the site is situated between (Metro Sites and East Walker Street) as follows:

- 1. provides a transition in building heights from the 24 storey Metro site and the 28 storeys at the corner of Walker Street and McLaren Street to the low scale heritage properties on the eastern side of Walker Street.
- 2. addresses the 2 storey wall height to the east of Walker Street and north of McLaren Street
- 3. protects the amenity and sunlight of existing and proposed public open spaces through a stepped and sculptured building envelope
- 4. facilitate the delivery of additional jobs and housing growth on the edge of the CBD in a short walk to the new metro station
- 5. activates the through-site link to improve the pedestrian experience and safety in and around the Ward Street precinct.
- 6. does not allow any overshadowing to Doris Fitton Park
- 7. adopts view sharing principles for new developments
- 8. respects the heritage items in regard to bulk, scale and aesthetics

key actions

create more jobs and housing opportunities near the Metro

support small to medium sized business growth

preserve heritage

identify access and active transport network improvements

provide a transition in building height

building height transition from the 24 storey Metro site and the 28 storeys at the corner of Walker Street and McLaren Street to the low scale heritage properties on the eastern side of Waler Street adress the 2 storey wall height

addressed to the east of Walker Street and north of McLaren Street protect amenity & sunlight

existing and proposed public open spaces protected through a stepped and sculptured building envelope facilitate additional jobs & housing growth

proposed mixed-use building on the edge of the CBD in a short walk to the new metro station

design principles & guidelines

improve pedestrian amenity

activate the through-site link to improve pedestrian experience and safety in and around the Ward Street precinct **√** hadowin

no overshadowing to Doris Fitton Park 1

view sharing for new developments respect heritage items

bulk, scale, aesthetics

CONSISTENCY WITH 10 AUGUST PRE-LODGEMENT MINUTES

The proposed design seeks to address the advice received from the Pre-Lodgement Meeting Minutes with North Sydney Council.

council feedback & design response



heritage consideration:

lower scale, leafy character of Walker Street

residential 2-3storey terraces along Walker Street. Podium aligns with heritage terraces, with landscaping, inkeeping with the street



heritage consideration: mixed-use character of McLaren Street

proposal mixed-use offering of retail and residential uses as a direct response to its surrounding heritage context



heritage consideration:

podium massing & setback set by heritage buildings

Walker Street podium setback to align with heritage terraces to the south. McLaren Street podium setback to align with 41 McLaren Street



heritage consideration:

scale / fine-grain nature / articulation / modulation of 150 Walker, and response to heritage items to east & west of site



community consultation

undertook community consultation/ engagement sessions including (1) Flyer Drop & Website LIVE, (2) Stake Holder One-on-One session, and (3) Community Engagement Virtual Session, which received positive feedback and support of the project.



public benefits

providing a carbon-neutral building, with the pedestrian through-site link widened to enhance the east-west connection towards the Ward Street Masterplan



mixed-use precint and response to a shared retail/ residential use to the podium

podium design responds to the residential character of Walker Street vs. the mixed-use character of McLaren Street



maximising engaging / active frontages along Walker Street

Raised residential terraces with street access, providing both activation and passive surveillance. A retail tenancy is provided on the corner of Walker/McLaren



Walker vs. Harnett Street site access study

report undertakes comparison between a traditional site access along Walker Street, vs. car-lift site access along Harnett Street



cycling and end-of-trip facilities

provided in the basement, with access from both McLaren Street and the through-site link



overshadowing

minor overshadowing that aligns with the goals of the North Sydney CBD Public Domain Strategy



tower sculpting

transitional stepping of tower (1) is in keeping with the series of stepped vertical massing that occurs along Walker Street, (2) maintains solar access to 150 Walker Street, and (3) provides solar access to the proposal





SITE PLAN

In keeping with North Sydney's approach of providing transitional massing along the fringes of the CBD and providing solar access to existing and proposed public spaces, the site proposes:

/a low-scale retail and residential podium that aligns and responds to the adjacent buildings

/a series of stepped and staggered landscaped terraces to the residential building that transitions from the low-scale buildings to the south, and the high-rise tower to the north.

/podium setback to the south of the site to widen and enhance the pedestrian through-site link

/Walker street setback to align with the heritage terraces south of the site












UPPER GROUND

Fronting McLaren Street, the indicative scheme provides building alignment with the adjacent building to the west, with an activated street frontage. This consists of (1) entry into the freshfood retail located along the north-west corner, followed by (2) the residential lobby, and (3) a cafe/dining offering.

As the site falls towards the south, individually expressed residential terraces are elevated off Walker Street, simultaneously providing both residential privacy and street surveillance. These can be accessed directly off the street, or from the McLaren Street residential lobby.

The southern elevation is set back 1.5m from the boundary, providing a wider pedestrian through-site link towards Harnett Street and the Ward Street Central Plaza.

To the west is an elevated retail offering that is set back 12m from 41 McLaren Street.

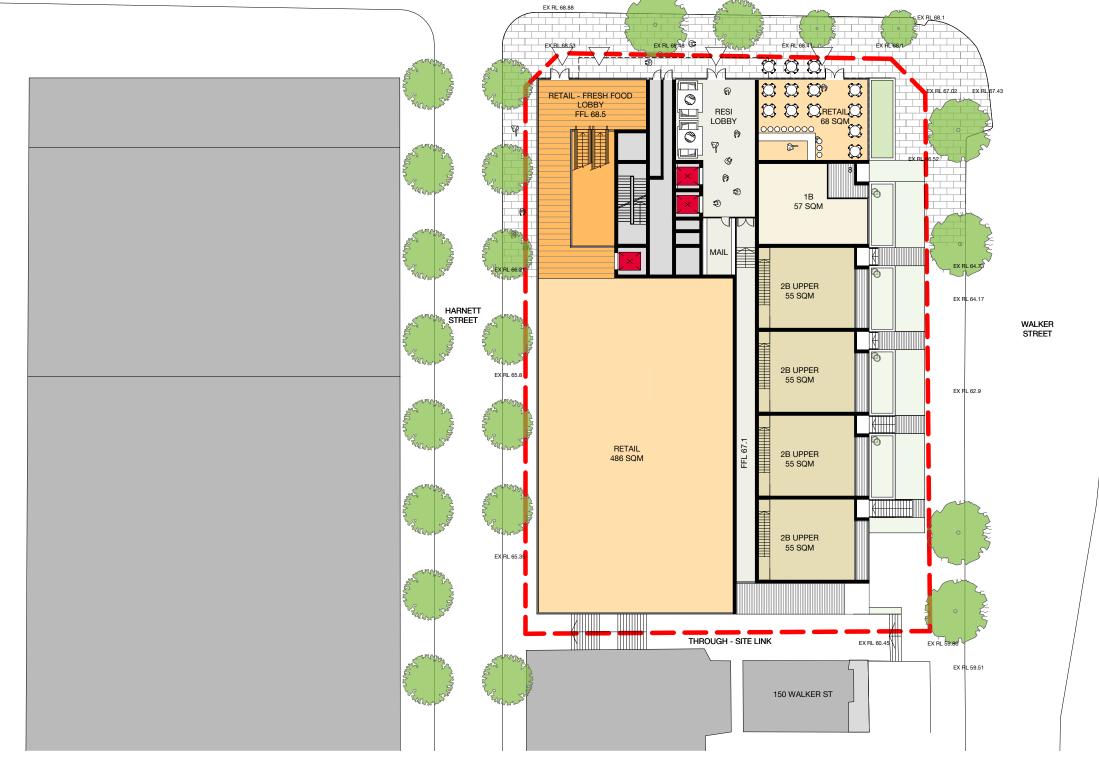







McLAREN STREET







GROUND

The ground level consists of the lower half of the residential terraces fronting Walker Street, and a retail fresh-food offering, with access from:

/McLaren Street via the escalators and retail lift

/Harnett Street, which also provides stair access to the gym, located on the level below















LOWER GROUND

The southern half of the site proposes gym facilities, and widens the pedestrian throughsite link with a 1.5m setback along the southern boundary. The gym receives natural daylight from the south and is accessed either from Harnett Street via stairs on the southwest corner, or from McLaren Street via the retail lift.

The northern half of the site, being underground, consists of the loading dock and carpark ramp to the basement levels below. These are accessed from the southeast corner of the site.















TYPICAL RESIDENTIAL FLOOR

The typical residential level proposes the following building alignments and setbacks:

/12m setback to 41 McLaren Street, along the northern half of the site, which then staggers for the southwest portion of the site to provide views to the future Ward Street Central Plaza

/building alignment with 41 McLaren Street along the northwest corner

/staggered apartments on the east to provide solar access to the apartments within the site and maintain solar access south of the site /3m setback along the southern boundary

The core is located on the northern half of the site, to cater for the building's stepped massing. Natural light is provided into the lobby from the north and west.

The typical residential floorplate consists of 8 apartments per floor, with the majority of apartments located on the east maximising on both solar amenity and views.



McLAREN STREET














ROOFTOP TERRACES

The proposal consists of a series of rooftop landscape terraces that cater for private residential use on levels 09-13 and level 15, as well as communal use on level 14.

The rooftop terraces has minimal overshadowing to the future Ward Street Central Plaza, and step away from the low-mid scale buildings of 150 Walker Street.

The top-most terrace floor consists of a 3 bedroom apartment and a 2-storey penthouse apartment.

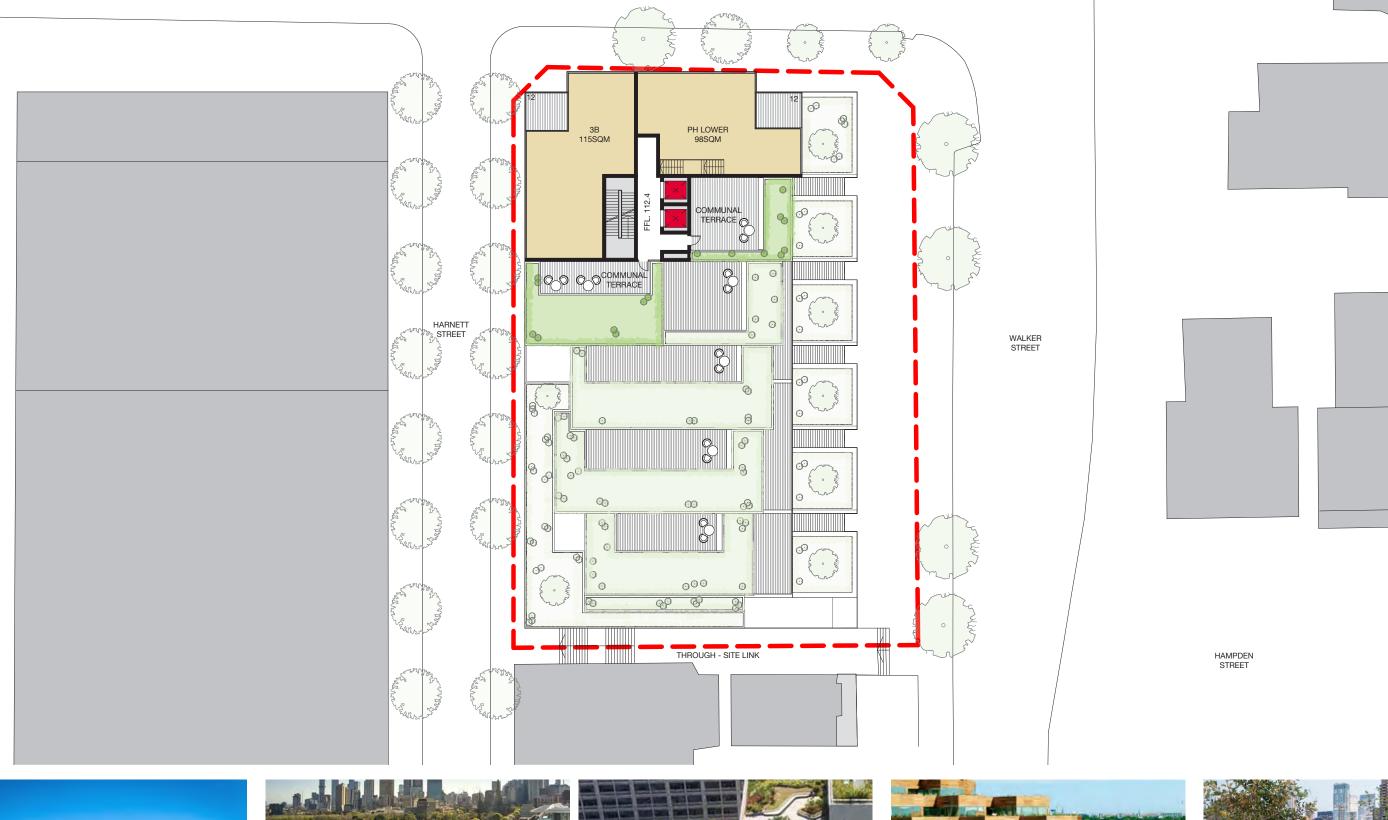

McLAREN STREET















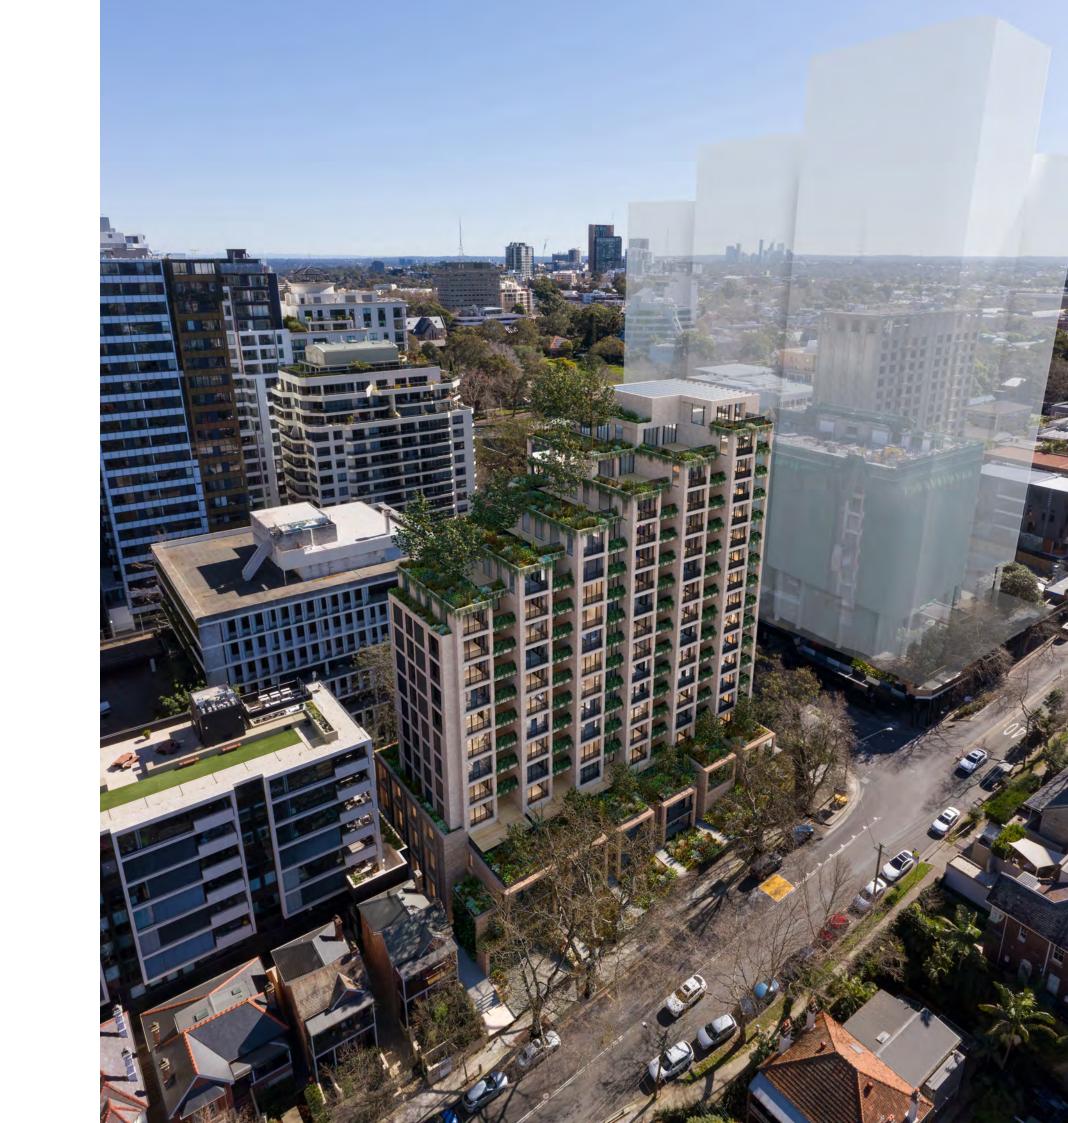


PODIUM SETBACK

Along McLaren Street, the indicative scheme maintains building alignment with the adjacent building to the west.

Along Walker Street, the podium is set back 5.5m from the eastern boundary to align with the heritage buildings of 150 Walker Street.

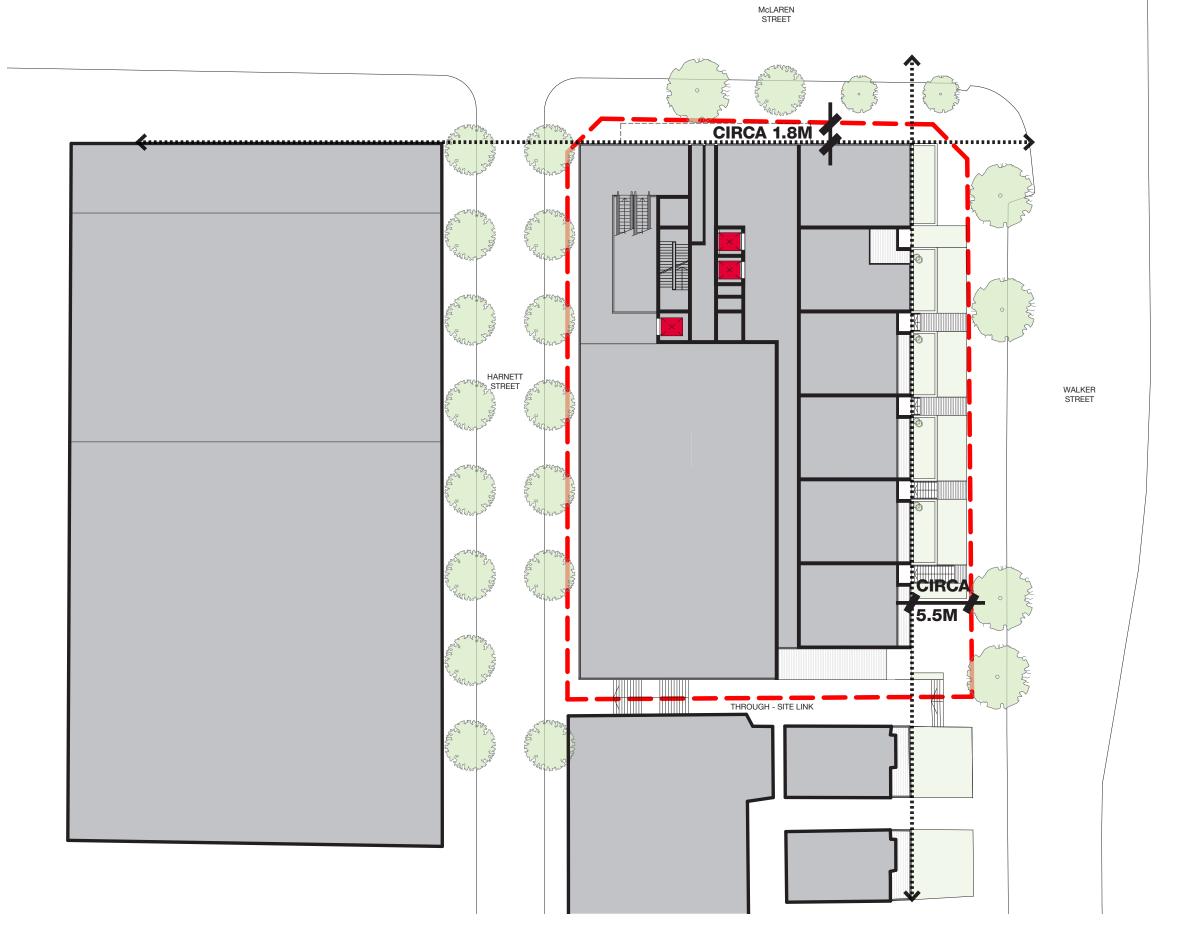

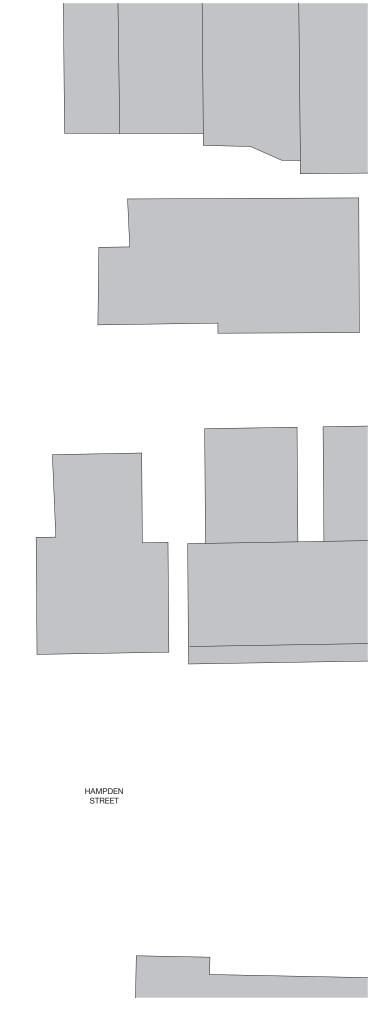



PODIUM HEIGHT & MODULATION

Responding to the heritage context, the proposal consists of 2-3 storey terraces that are in-keeping with the datum created by the adjacent heritage terraces.

The 6m modules of the proposed terraces, which are both elevated and have direct street access further relates to the surrounding heritage context.





THROUGH-LINK WIDENED & ACTIVATED

The through-site link has been widened to double its original width, providing a more generous pedestrian connection between Walker and Harnett Streets.

The three levels of retail along the southern end of the site further provides passive activation and surveillance along the through-site link.





BATESSMART






AERIAL EXISTING



AERIAL PROPOSED

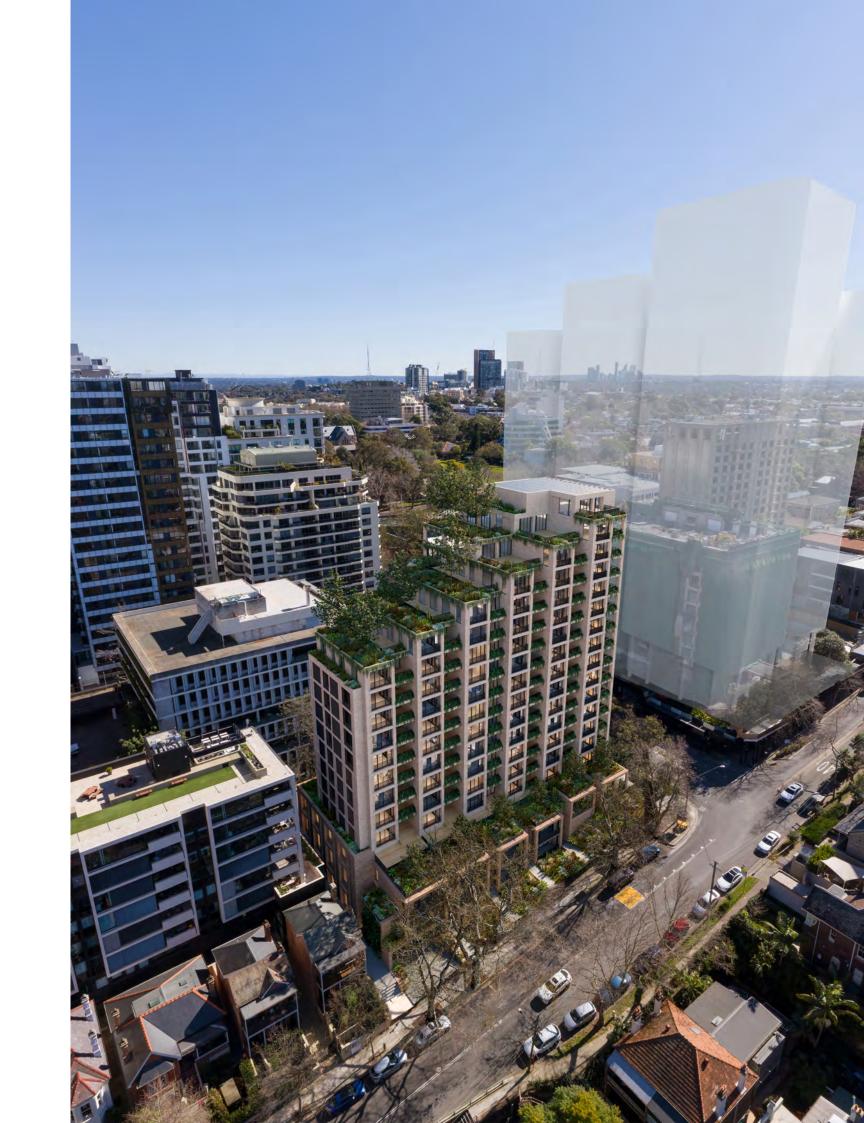

WALKER STREET LOOKING NORTH EXISTING



BATESSMART...

WALKER STREET LOOKING NORTH PROPOSED



BATESSMART...

WALKER STREET EXISTING



WALKER STREET PROPOSED



SOLAR ANALYSIS WINTER SOLSTICE 21 JUNE

As demonstrated through the following shadow diagrams, the building seeks to provide good solar amenity to the public spaces proposed in the Ward Street Masterplan.

The Civic Plaza, highlighted in orange, is partially overshadowed by the proposal between 9-10am in the winter solstice, the lowest sun angle throughout the year.


















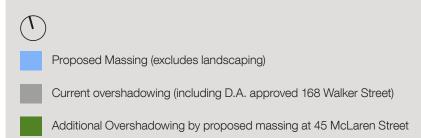


Additional Overshadowing by Ward Street Masterplan / Civic Precinct Study / Walker Street Gateway Determined Planning Proposal

Proposed Public space (Good Solar Access all year Round as per North Sydney CBD Public Domain Strategy)

Proposed Public space (Good Solar Access Spring to Autumn as per North Sydney CBD Public Domain Strategy)

SOLAR ANALYSIS WINTER AVERAGE 12 JULY


As demonstrated through the following shadow diagrams, the proposed envelope also has minimal impact during the average of winter.

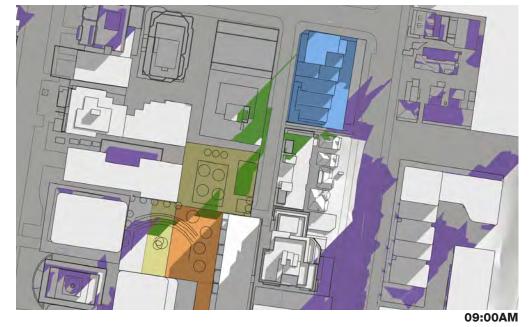








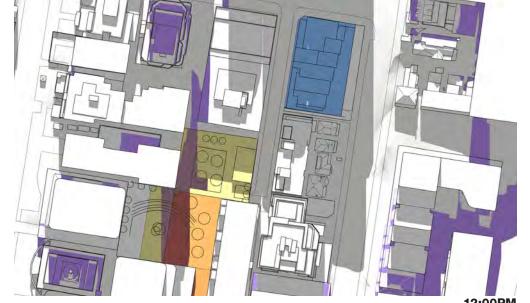



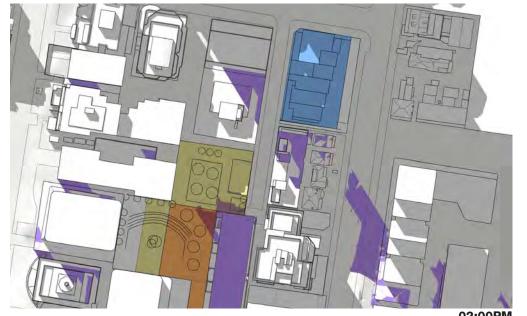






SOLAR ANALYSIS SPRING EQUINOX 22 SEPTEMBER


During Spring and Summer, the proposal results in no additional overshadowing to both the Civic Plaza and the yellow zones of the Ward Street plaza.








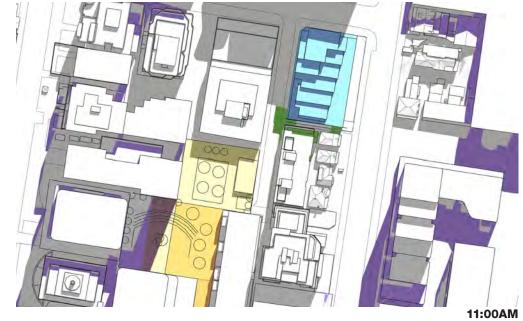


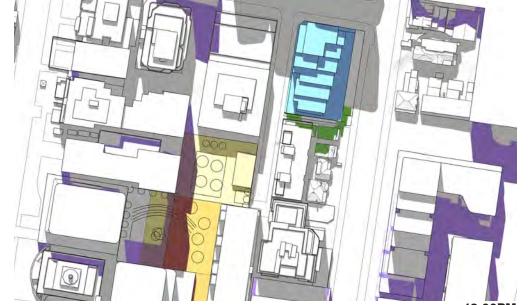

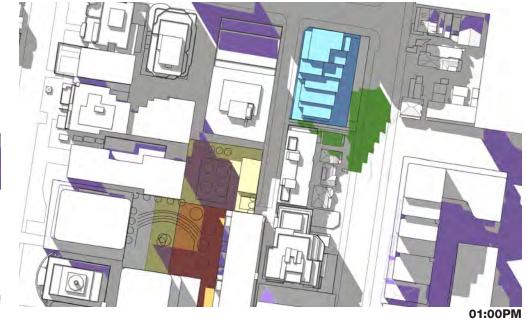





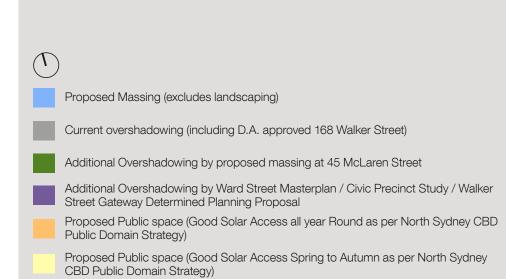


ADG COMPLIANCE

SOLAR ACCESS

A total of 65% of dwellings receive 2 hours solar access to living rooms and balconies between 9am and 3pm on June 21st.

CROSS VENTILATION

To improve residential amenity, the scheme has been designed to maximise the number of dwellings which are naturally cross-ventilated. A total of 64% of dwellings in the first nine storeys of the building have more than one aspect and are therefore deemed to be naturally cross-ventilated.

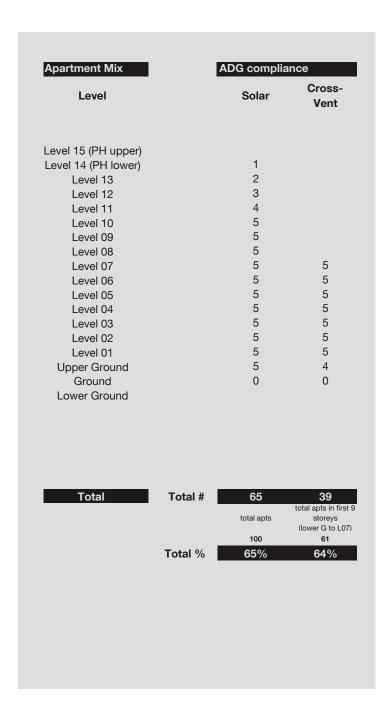

L00 UPPER

4 of 5

LEVEL 01-07

5 of 8



LEVEL 14

1 of 2

LEVEL 13

2 of 4

AREA SCHEDULE

The adjacent area schedule indicates the floor by floor Gross Floor Area (GFA) for the proposed envelope and apartment mix.

TOTAL FLOOR SPACE

1,792 sqm Site Area Residential GFA 11,083 sqm Retail / Comm GFA 2,168 sqm Total GFA 13,251 sqm **FSR** 7.5 :1 Maximum Height 61 m

16 storeys @ north boundary Storeys 12 storeys @ south boundary Storeys

RESIDENTIAL MIX

100 units Dwellings

Comprising 17 one bedroom apartments

65 two bedroom apartments

18 three bedroom apartments

GFA DEFINITION

gross floor area means the sum of the floor area of each floor of a building measured from the internal face of external walls, or from the internal face of walls separating the building from any other building, measured at a height of 1.4 metres above the floor, including:

(a) the area of a mezzanine, and

(b) habitable rooms in a basement or an attic, and

(c) any shop, auditorium, cinema, and the like, in a basement or

excluding:

(d) any area for common vertical circulation, such as lifts and stairs, and

(e) any basement:

(i) storage, and

(ii) vehicular access, loading areas, garbage and services, and (f) plant rooms, lift towers and other areas used exclusively for mechanical services or ducting, and

(g) car parking to meet any requirements of the consent authority (including access to that car parking), and

(h) any space used for the loading or unloading of goods (including access to it), and

(i) terraces and balconies with outer walls less than 1.4 metres

(j) voids above a floor at the level of a storey or storey above.

Level	Function	RL	Height	Residential	Retail / Commercial	Combined GFA
				GFA (sqm)	GFA (sqm)	(sqm)
Roof Parapet		118.7				
Level 15 (PH upper)	Residential	115.5	3.2	152		152
Level 14 (PH lower)	Resi / Terrace	112.4	3.1	250		250
Level 13	Resi / Terrace	109.3	3.1	398		398
Level 12	Resi / Terrace	106.2	3.1	474		474
Level 11	Resi / Terrace	103.1	3.1	599		599
Level 10	Resi / Terrace	100.0	3.1	718		718
Level 09	Resi / Terrace	96.9	3.1	801		801
Level 08	Residential	93.8	3.1	818		818
Level 07	Residential	90.7	3.1	818		818
Level 06	Residential	87.6	3.1	818		818
Level 05	Residential	84.5	3.1	818		818
Level 04	Residential	81.4	3.1	818		818
Level 03	Residential	78.3	3.1	818		818
Level 02	Residential	75.2	3.1	818		818
Level 01	Residential	72.1	3.1	818		818
Upper Ground	Retail / Residential	68.5	3.6	474	680	1154
Ground	Retail	64	4.5	250	951	1201
Lower Ground	Retail / Loading	60	4	43	537	580
Basement 01	Car Parking	57	3	380		380
Basement 02	Car Parking	54	3			
Basement 03	Car Parking	51	3			
Basement 04	Car Parking	48	3			
Total			70.7	11,083	2,168	13,251

Level 15 (PH upper) Level 14 (PH lower) Level 13 1 2 1 4 Level 12 1 1 2 4 Level 10 1 2 2 2 6 Level 09 1 1 5 1 8 Level 08 1 1 5 1 8 Level 07 1 1 5 1 8 Level 06 1 1 5 1 8 Level 05 1 1 5 1 8 Level 04 1 1 5 1 8 Level 03 1 1 5 1 8 Level 03 1 1 5 1 8 Level 04 1 1 5 1 8 Level 05 1 1 5 1 8 Level 07 1 1 5 1 8 Level 08 1 1 5 1 8 Level 09 1 1 1 1 5 1 8 Level 09 1 1 1 1 1 1 1 1 1 1 1 1 1 1 1 1 1 1	Level	1B	1B+	2B	2B+	3B	Total
Level 06 1 1 5 1 8 Level 05 1 1 5 1 8 Level 04 1 1 5 1 8 Level 03 1 1 5 1 8 Level 02 1 1 5 1 8 Level 01 1 1 5 1 8 Upper Ground 1 4 5 Ground 0	Level 14 (PH lower) Level 13 Level 12 Level 11 Level 10 Level 09 Level 08	1 1 1 1		1	1 2 2 5 5	1 2 2 2 1 1	2 4 4 6 7 8 8
Lower Ground	Level 06 Level 05 Level 04 Level 03 Level 02 Level 01 Upper Ground	1 1 1 1 1		1 1 1 1 1	5 5 5 5	1 1 1 1	8 8 8 8 8 5
							0






SITE ACCESS


The following investigates the suitability of site access / carpark facilities when accessed from Walker Street versus Harnett Street based on the following criteria:

- / response to heritage
- / vehicular access & residential amenity
- / provision for parking to fresh food retail
- / active street frontage / safety
- / access into retail spaces
- / daylight to retail space

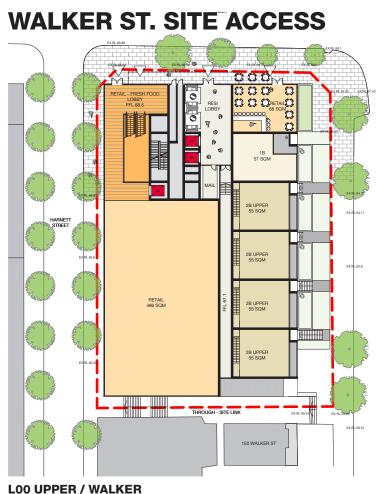






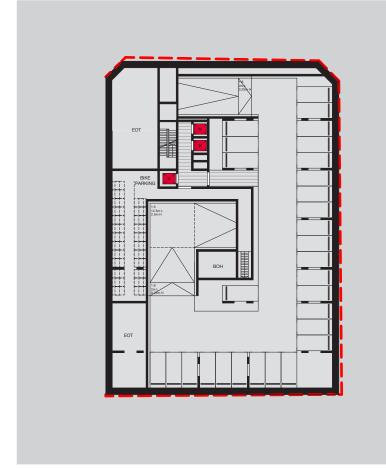


BASEMENT 01 / WALKER

HARNETT ST. SITE ACCESS



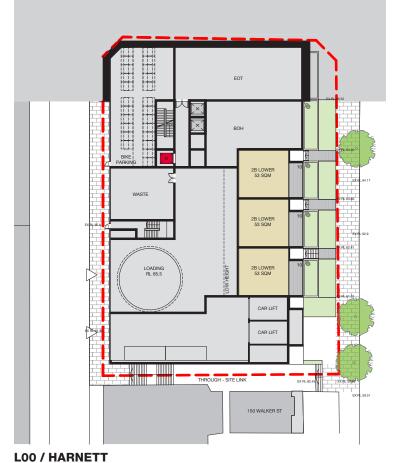

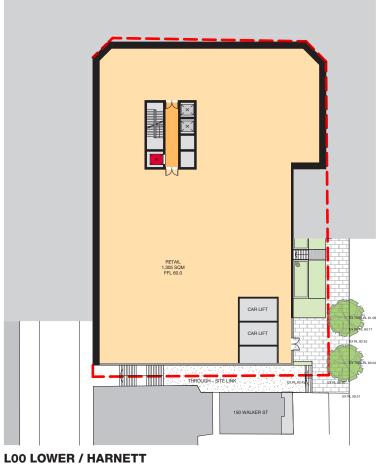



BASEMENT 01 / HARNETT


SITE ACCESS STUDY COMPARISON


total retail GFA	WALKER ST. SITE ACCESS	HARNETT ST. SITE ACCESS X 1,600 sqmm (-568)
response to heritage	√ residential terrace adjacent to 150 walker terraces	x car lift / inactive facade adjacent to 150 walker terrace
vehicular access / residential amenity	√ traditional ramp	x car lift
provision for parking to fresh food retail	√ traditional ramp = retail parking	x car lift = no retail parking
active street frontage / safety	 ✓ Walker ✓ McLaren ✓ Harnett ✓ Through link (lower ground) ✓ Through link (ground) 	 ✓ Walker ✓ McLaren X Harnett ✓ Through link (lower ground) X Through link (ground)
access into retail spaces	✓ Through link (upper ground)✓ McLaren✓ Harnett	X Through link (upper ground)✓ McLarenX compromised access at Walker
daylight to retail space	√ daylight from McLaren / Harnett / through-site link	x majority of retail is subterranean
√ X TOTAL	+13 -0 +13	+4 -9 -5



TYPICAL APARTMENT LAYOUTS


The typical apartment layouts provide open-plan outboard living, and efficient apartment planning.

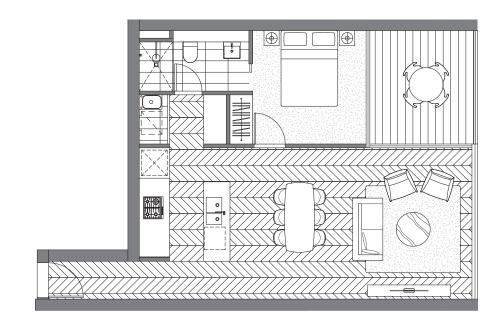

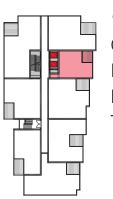

1BED EAST

Orientation: East
Internal area: 56sqm
Balcony area: 8sqm
Total area: 64sqm

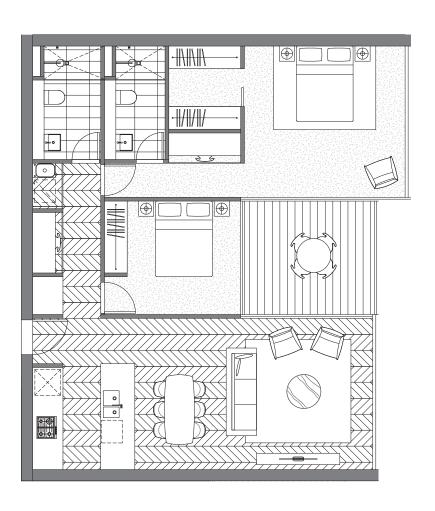




2BED EAST

Orientation: East
Internal area: 93sqm
Balcony area: 10sqm
Total area: 103sqm

TYPICAL APARTMENT LAYOUTS


The typical apartment layouts provide open-plan outboard living, and efficient apartment planning.

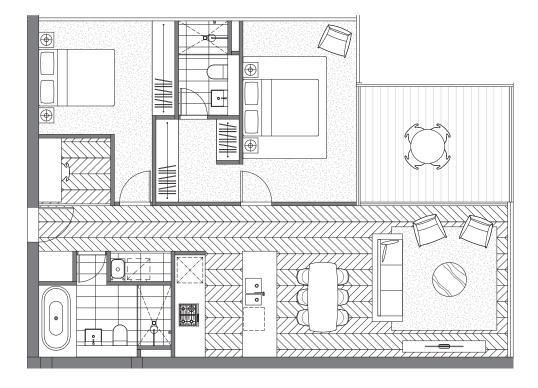




2BED NORTH-EAST

Orientation: North-east Internal area: 91sqm
Balcony area: 12sqm
Total area: 103sqm

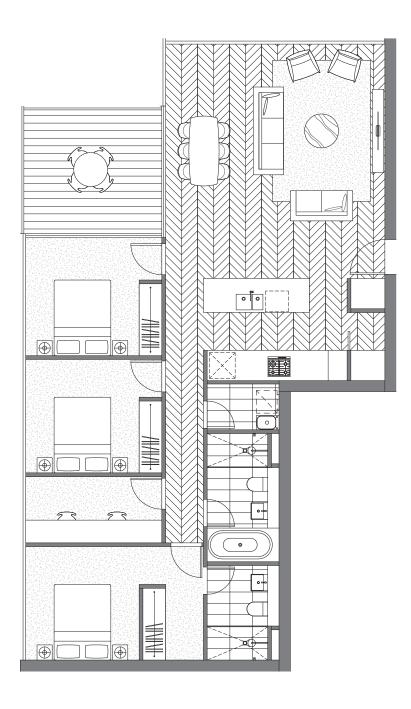

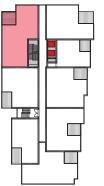

3BED NORTH-WEST

Orientation: North-west
Internal area: 115sqm
Balcony area: 12sqm
Total area: 127sqm




DRAWING SET 45 McLAREN STREET, NORTH SYDNEY

September 2020		
Drawing No.	Drawing	Scale
400.000	Cover Sheet	
A01.001	Site Plan	1:500 @ A1
A02.B01	Basement 01	1:200 @ A1
A02.B02	Basement 02-04	1:200 @ A1
402.00L	Level 00 Lower	1:200 @ A1
A02.00M	Level 00	1:200 @ A1
A02.00U	Level 00 Upper	1:200 @ A1
A02.001	Level 01	1:200 @ A1
A02.002	Level 02-08	1:200 @ A1
A02.009	Level 09	1:200 @ A1
A02.010	Level 10	1:200 @ A1
A02.011	Level 11	1:200 @ A1
A02.012	Level 12	1:200 @ A1
A02.013	Level 13	1:200 @ A1
A02.014	Level 14	1:200 @ A1
A02.015	Level 15	1:200 @ A1
A09.001	Walker Street Elevation	1:200 @ A1
A09.002	Harnett Street Elevation	1:200 @ A1
A10.001	Section AA	1:200 @ A1
A10.002	Section BB	1:200 @ A1
A10.101	Street Section Walker	1:100 @ A1
A10.102	Street Section Harnett	1:100 @ A1
A10.103	Street Section Fast-West	1:100 @ A1





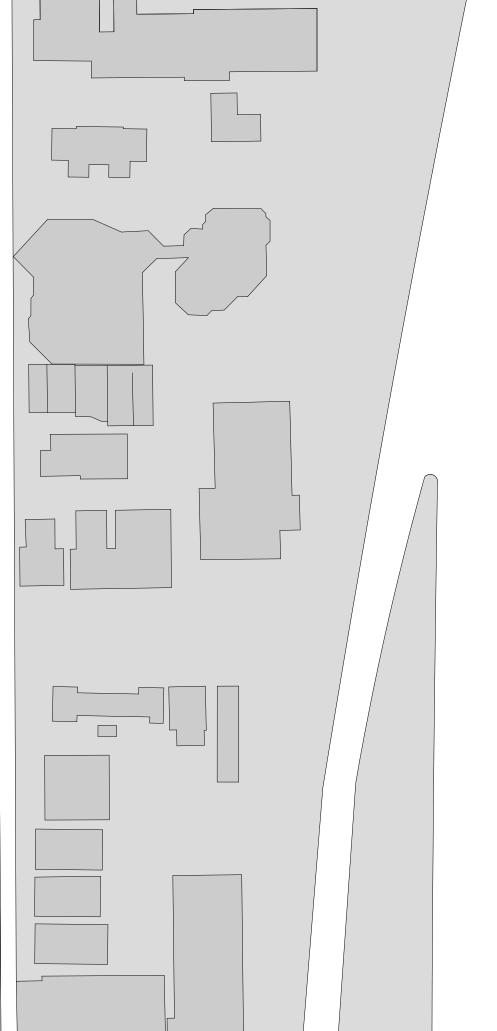

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S12400 45 McLaren Street

A01 Site Plan



Status	Planning Proposal		
Scale	1:500 @ A1		
Drawn	JC	Checked	MD
Project No.	S12400		
Plot Date	28/09/2020 6:44:36 PM		
BIM	MCLARENST_BS_ARCH_F	R2020	
Drawing no.		Revision	


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S12400 45 McLaren Street

Basement 02-04




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BIM	MCLARENST_BS_ARCH_F	R2020	
Drawing no.		Revision	

A02.B02
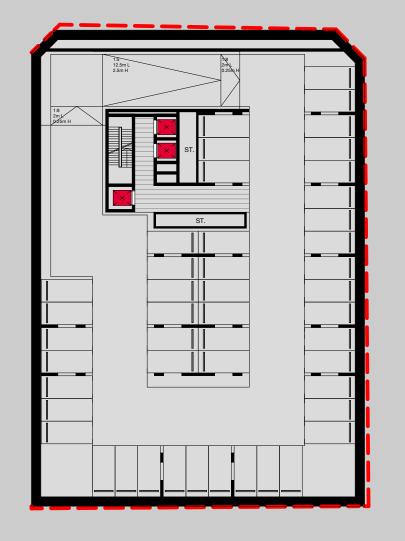
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A02 Basement 01



Status	Planning Proposal		
Scale	1:200 @ A1		
Drawn	JC	Checked	MD
Project No.	S12400		
Plot Date	18/09/2020 1:45:37 PM		
BIM	MCLARENST_BS_ARCH_F	R2020	
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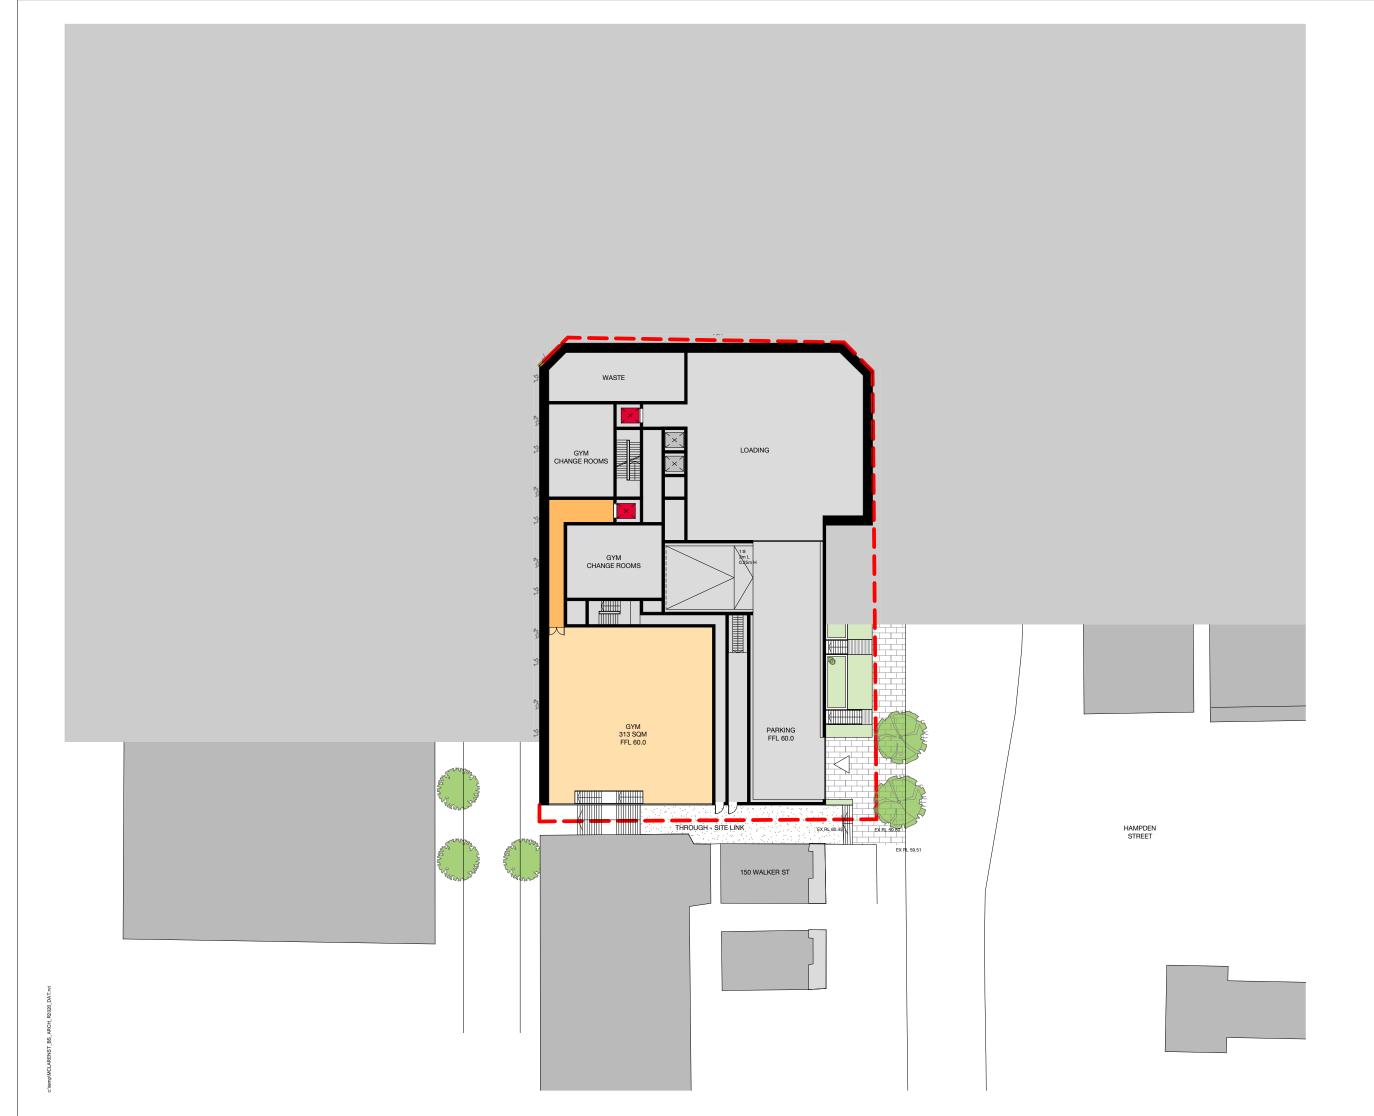
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S12400 45 McLaren Street

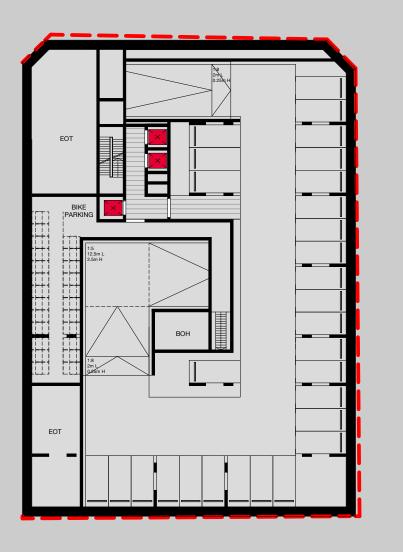A02 Level 00 Lower




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Drawing no.		Revision	

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A02 Level 00



Status	Planning Proposal		
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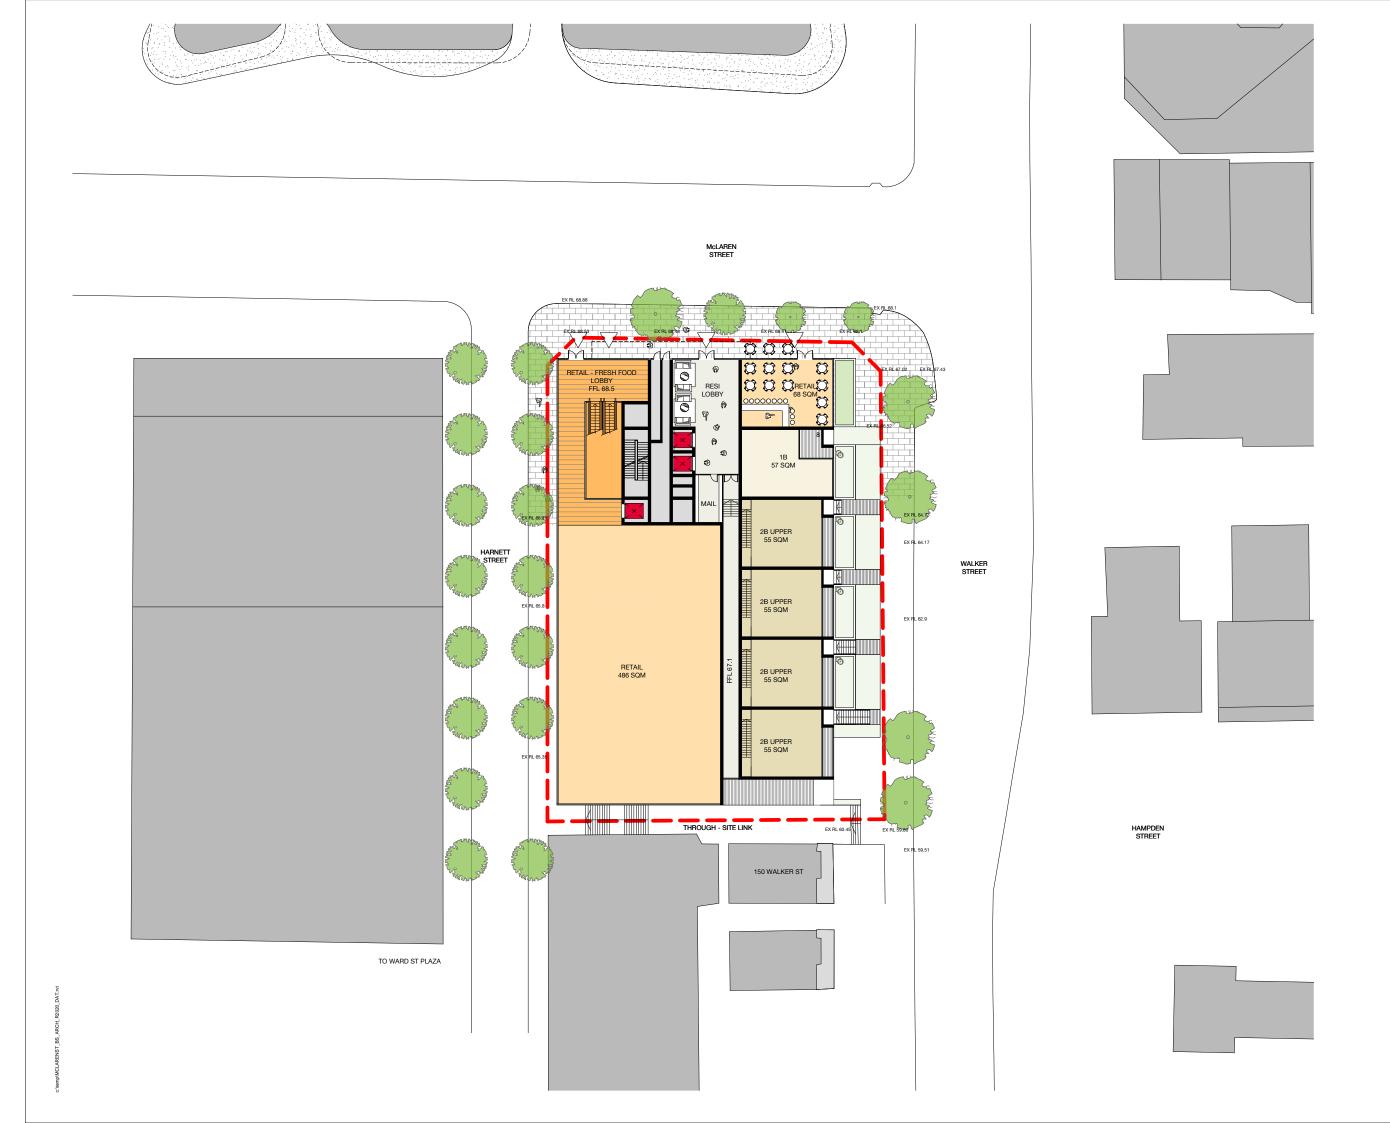
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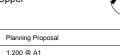
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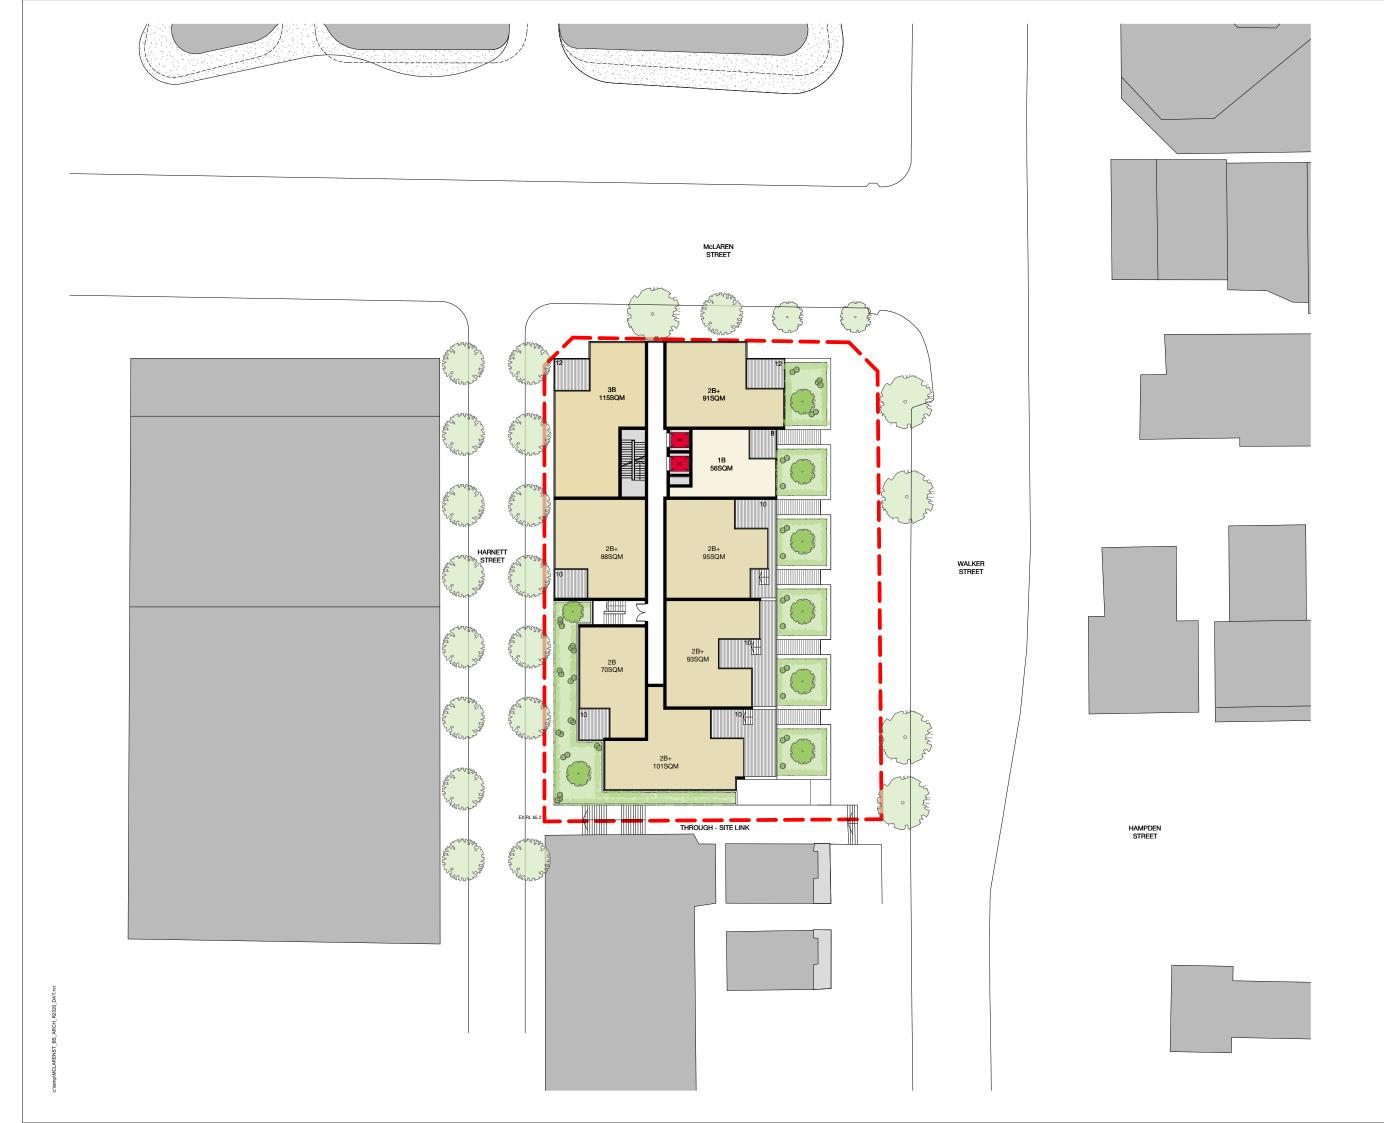
A02 Level 00 Upper

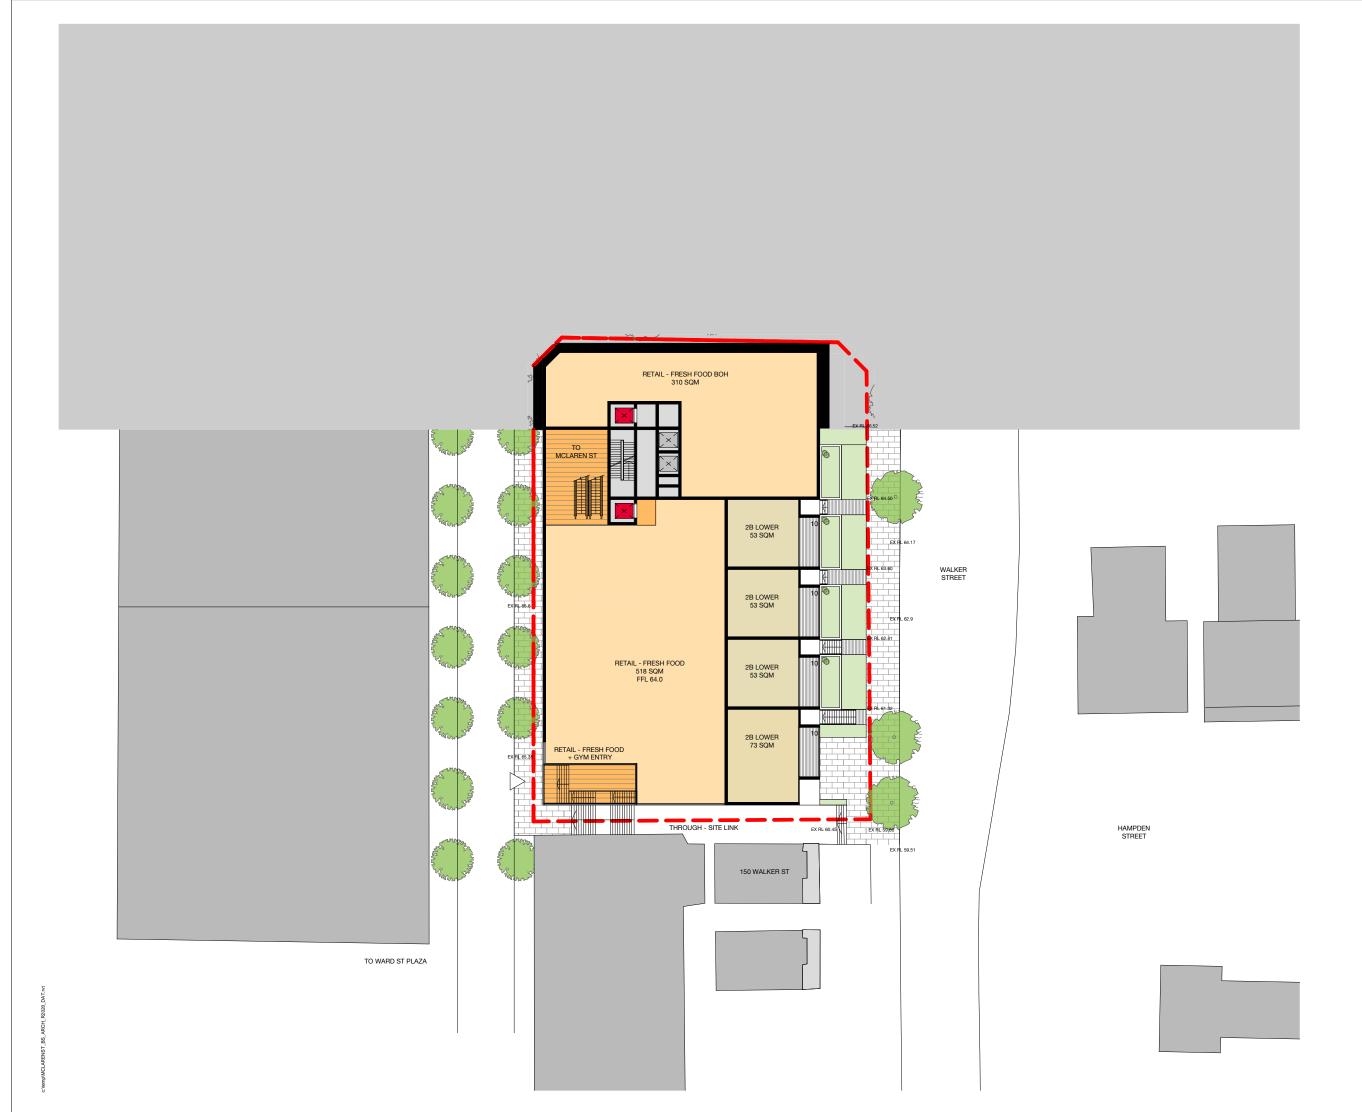

A02.00U

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A02




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A02.001

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A02 Level 02-08




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Drawing no.		Revision	

A02.002
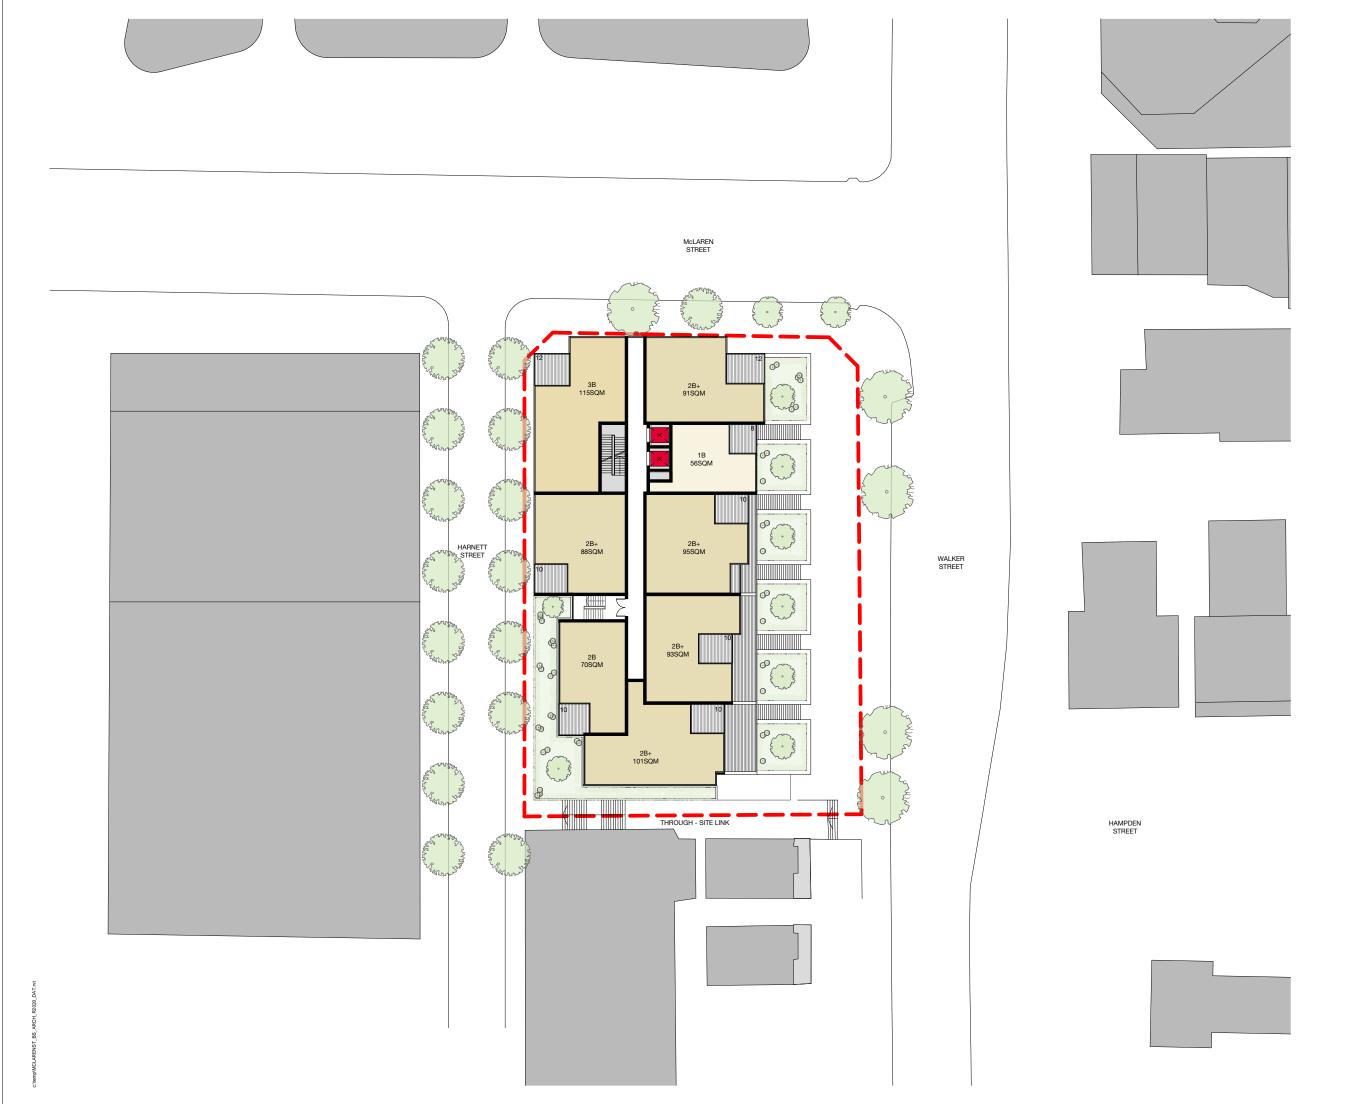
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Rev Date Description Initial Check

S12400 45 McLaren Street

A02

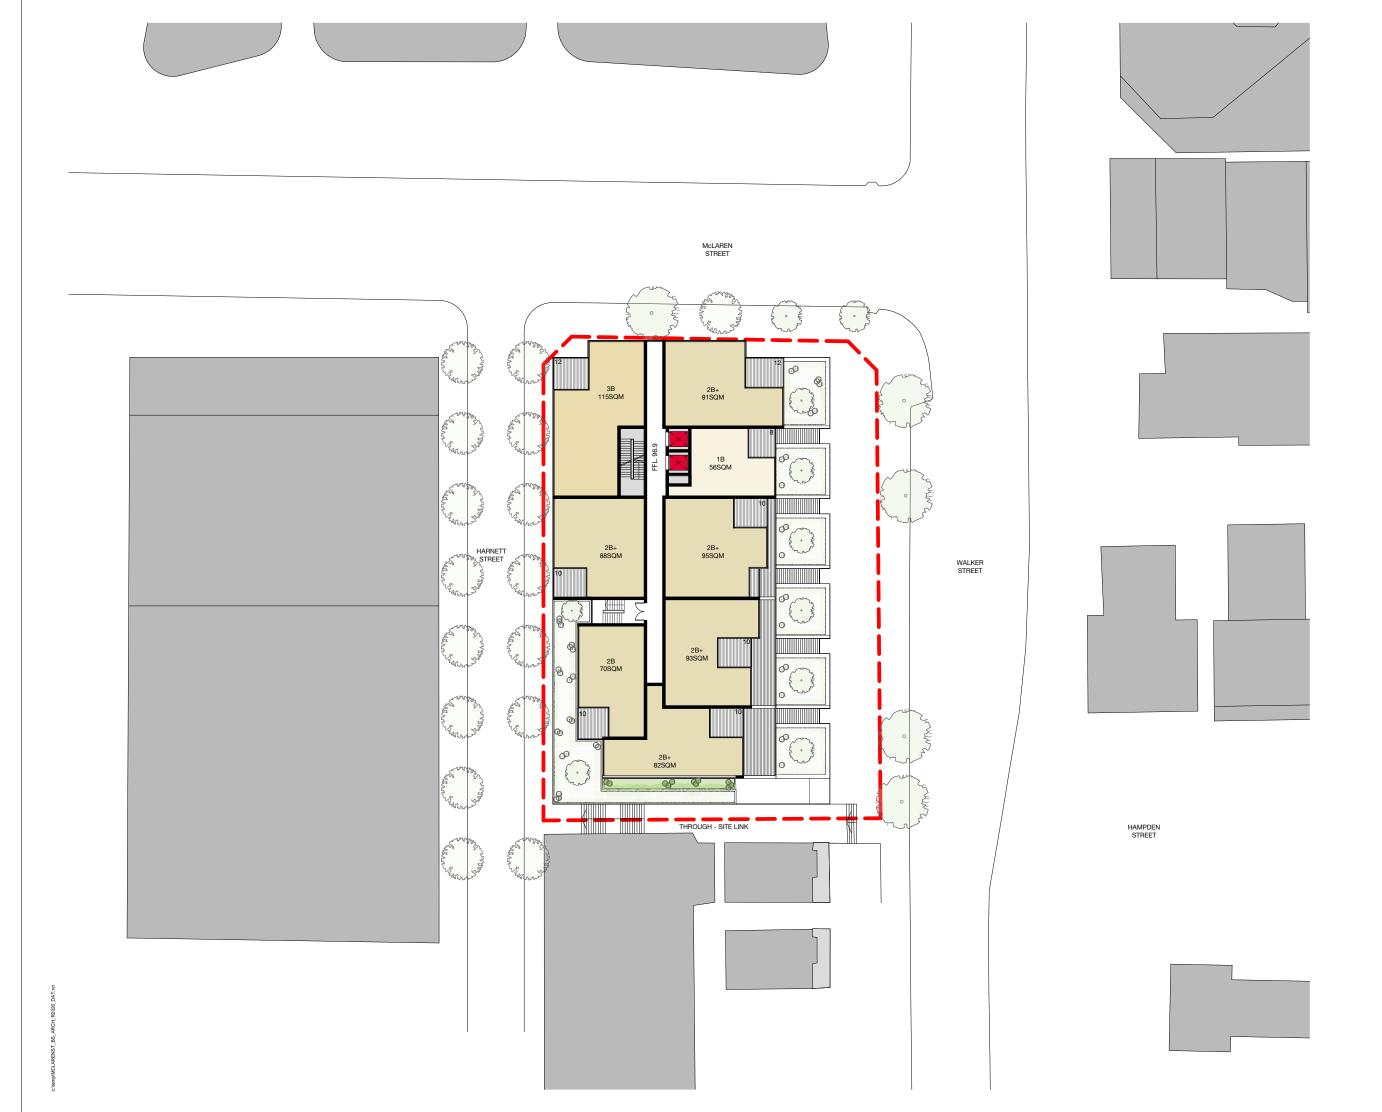


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BIM	MCLARENST_BS_ARCH_F	R2020	
Drawing no.		Revision	

A02.009

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A02




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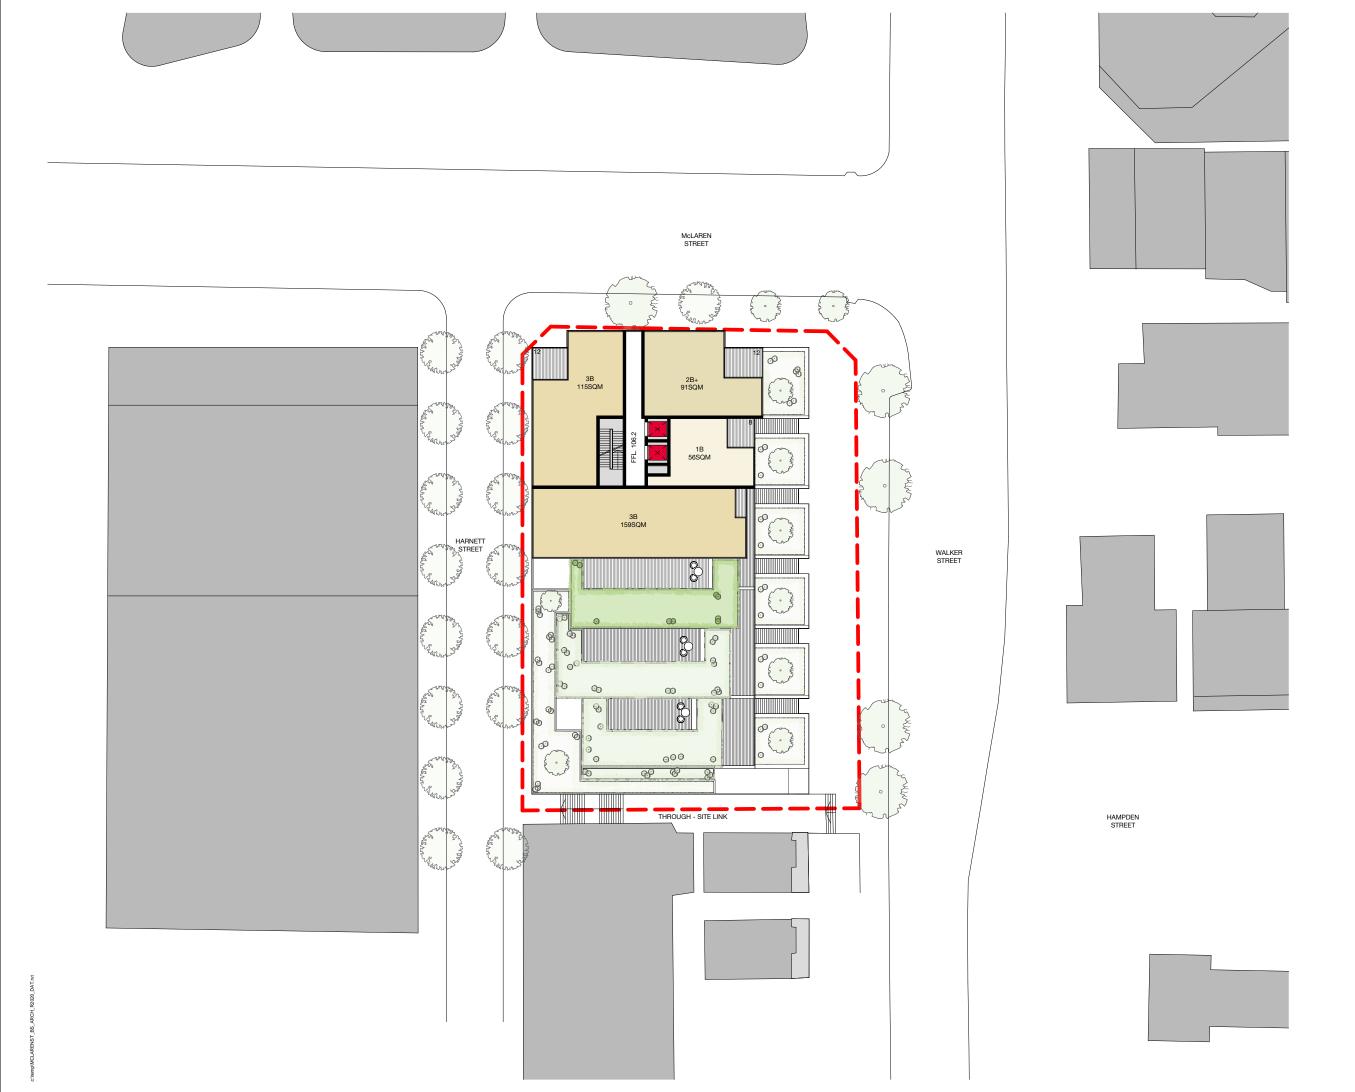
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Status	Planning Proposal		
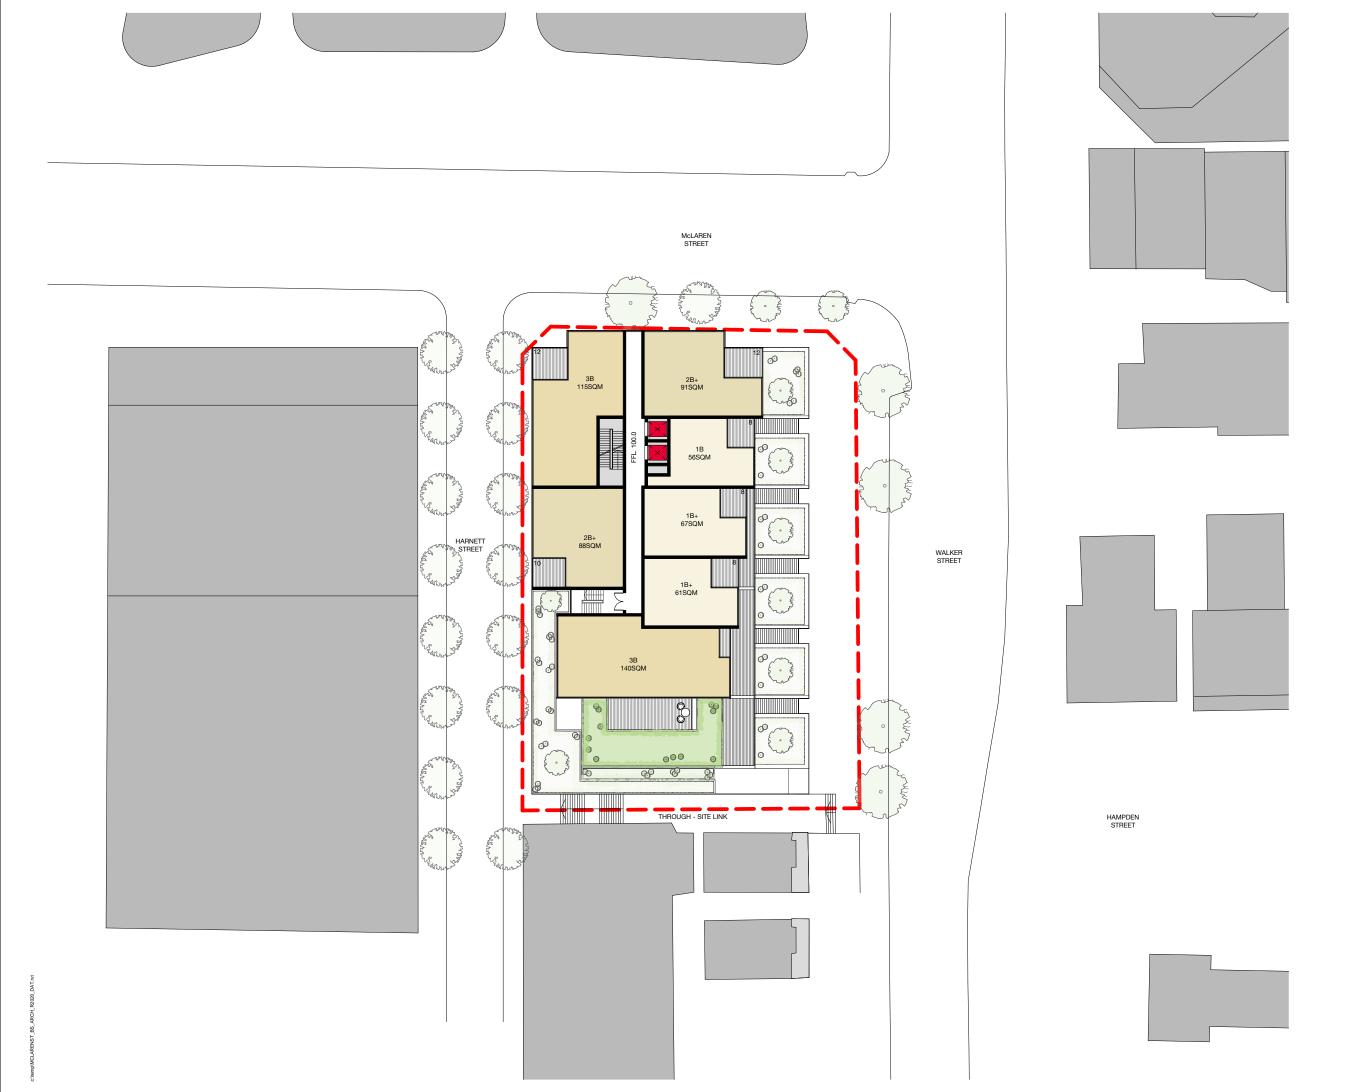
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S12400 45 McLaren Street

A02




Status	Planning Proposal		
Scale	1:200 @ A1		
Drawn	JC	Checked	MD
Project No.	S12400		
Plot Date	18/09/2020 1:53:38 PM		
BIM	MCLARENST_BS_ARCH_R	2020	

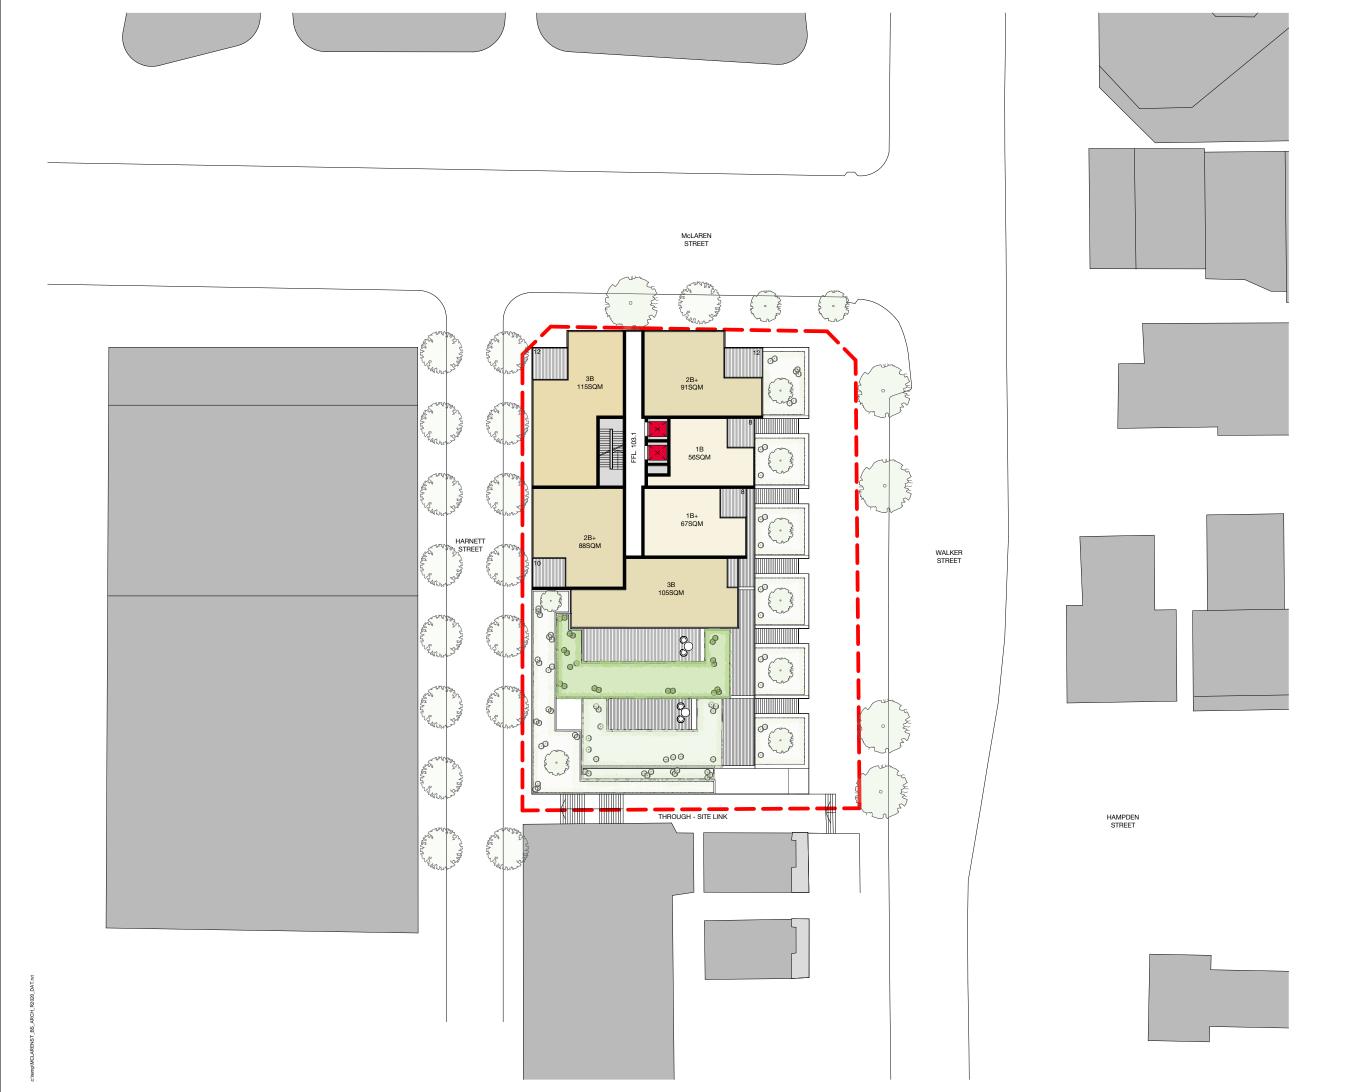A02.012

Melbourne 1 Nicholson Street Melbourne VIC 3000 Australia T 03 8684 6200 F 03 8684 6300 email mel@batessmart.com.au http://www.batessmart.com.au

Sydney 43 Brisbane Street Surry Hills NSW 2010 Australia T 02 8354 5100 F 02 8354 5199 email syd@batessmart.com.au http://www.batessmart.com.au

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S12400 45 McLaren Street

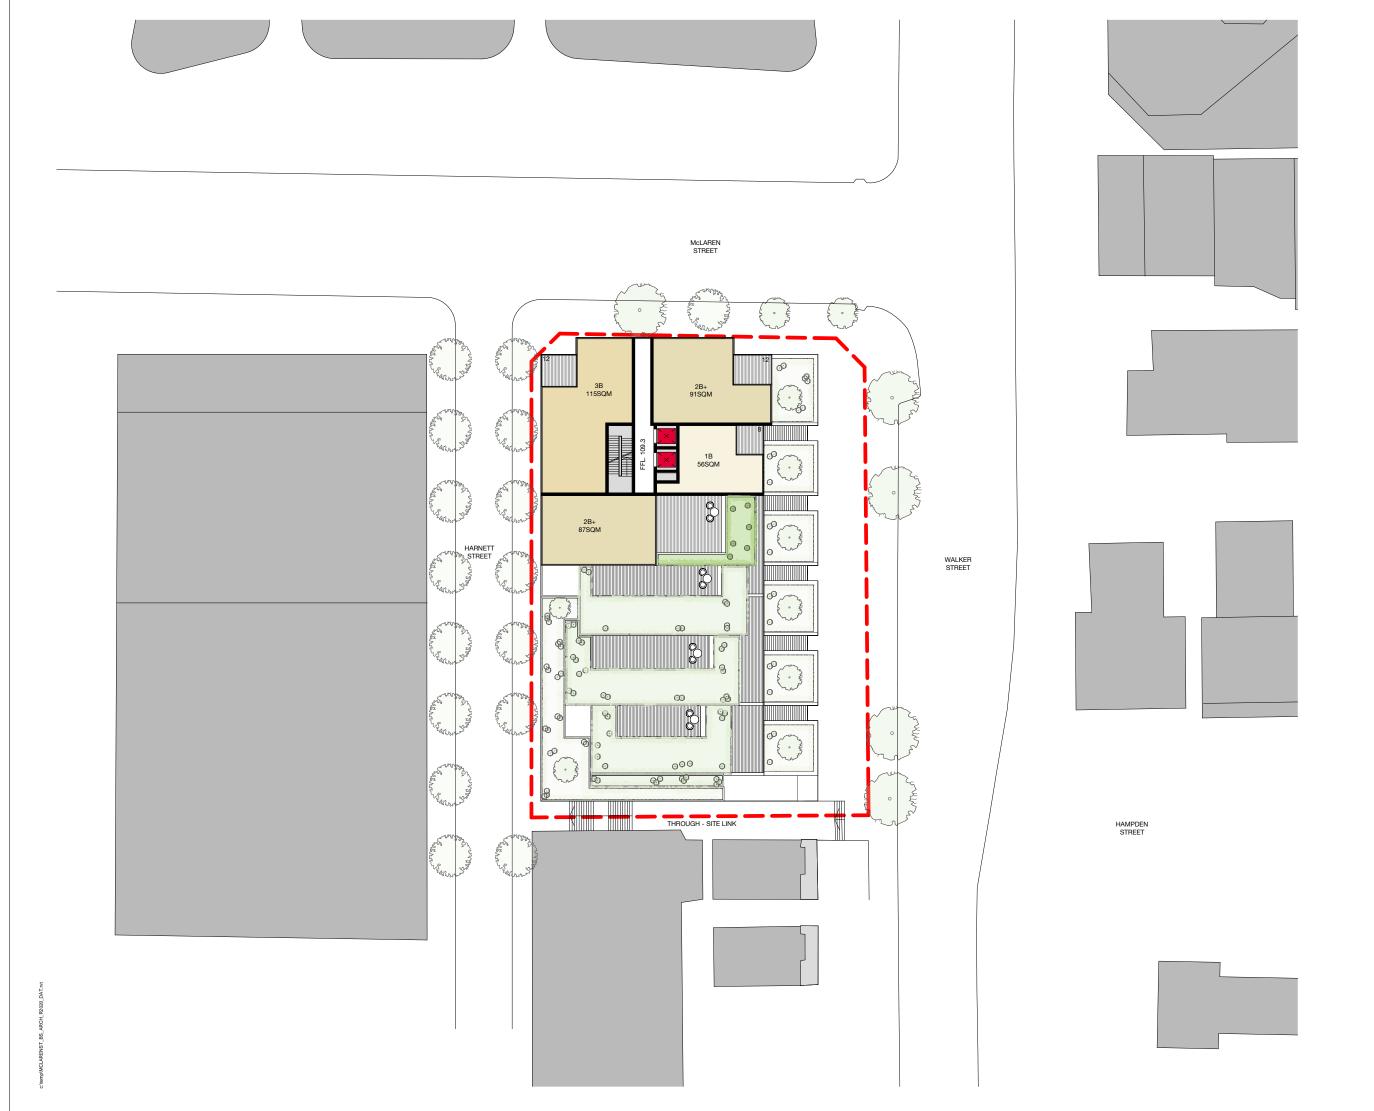A02




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	Planning Proposal		
Scale	1:200 @ A1		
Drawn	JC	Checked	MD
Project No.	S12400		
Plot Date	18/09/2020 1:55:37 PM		
BIM	MCLARENST_BS_ARCH_R	2020	

A02.013

Melbourne 1 Nicholson Street Melbourne VIC 3000 Australia T 03 8664 6200 F 03 8664 6300 email mel@batessmart.com.au http://www.batessmart.com.au

Sydney 43 Brisbane Street Surry Hills NSW 2010 Australia T 02 8354 5100 F 02 8354 5199 email syd@batessmart.com.au http://www.batessmart.com.au

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S12400 45 McLaren Street

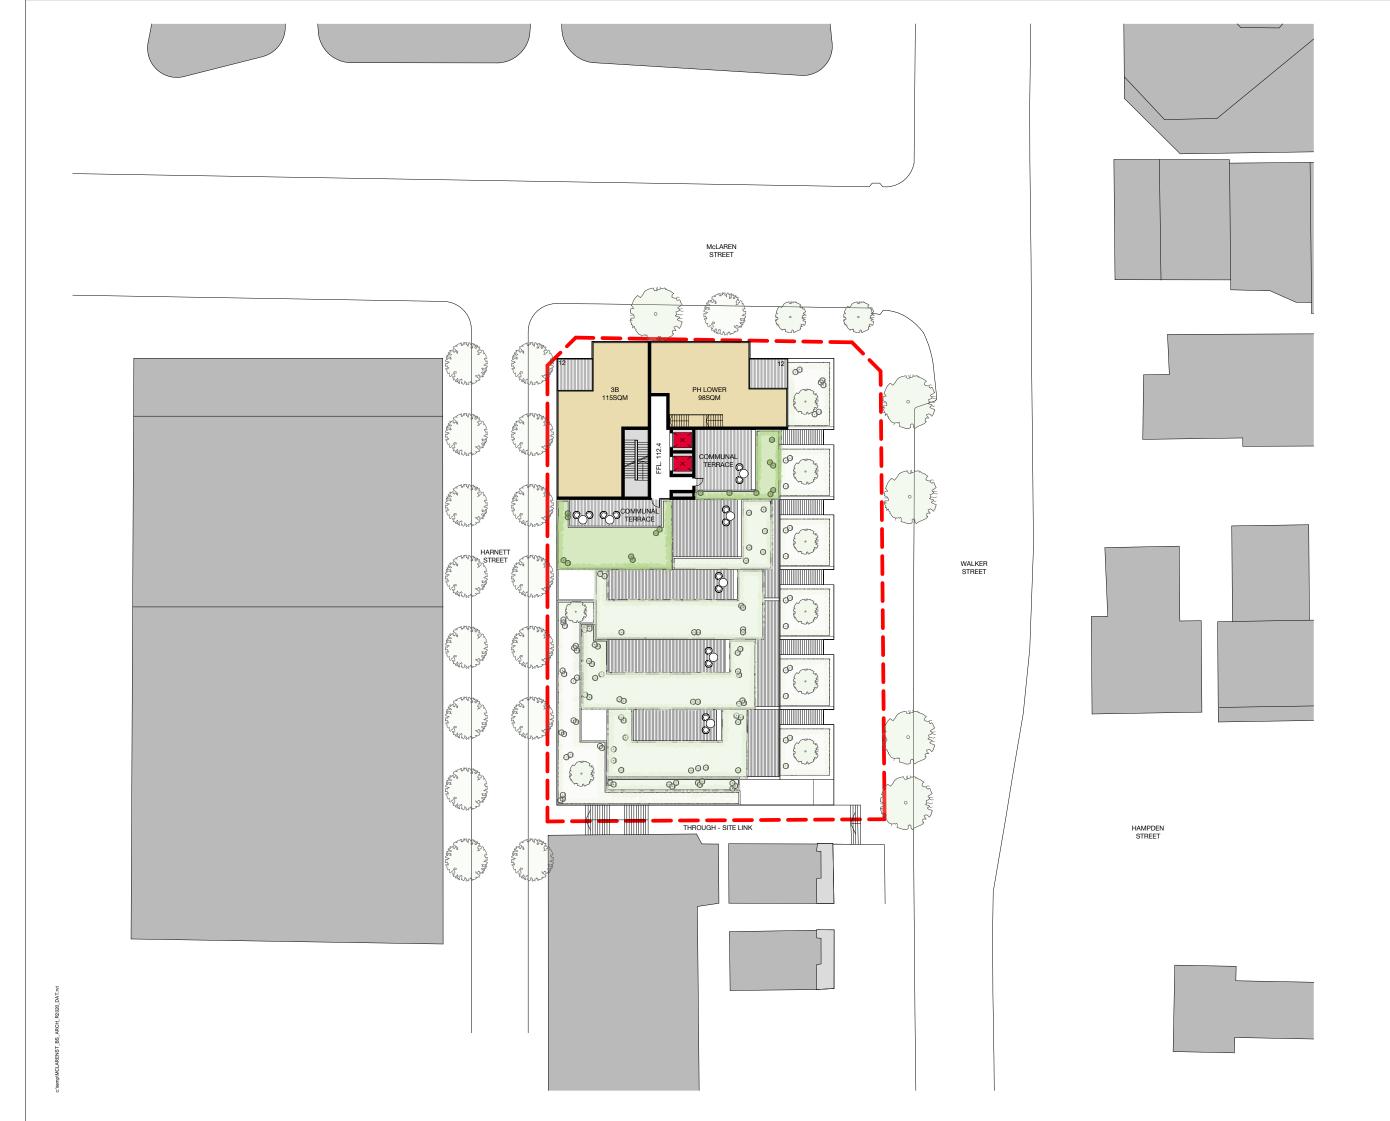A02




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Drawn	JC	Checked	MD
Project No.	S12400		
Plot Date	18/09/2020 1:57:49 PM		
BIM	MCLARENST_BS_ARCH_F	R2020	

A02.014

Melbourne 1 Nicholson Street Melbourne VIC 3000 Australia T 03 8684 6200 F 03 8664 6300 email mel@batessmart.com.au http://www.batessmart.com.au

Sydney 43 Brisbane Street Surry Hills NSW 2010 Australia T 02 8354 5100 F 02 8354 5199 email syd@batessmart.com.au http://www.batessmart.com.au

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2 07.09.20 Issue for Information MD MD
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Rev Date Description Initial Check

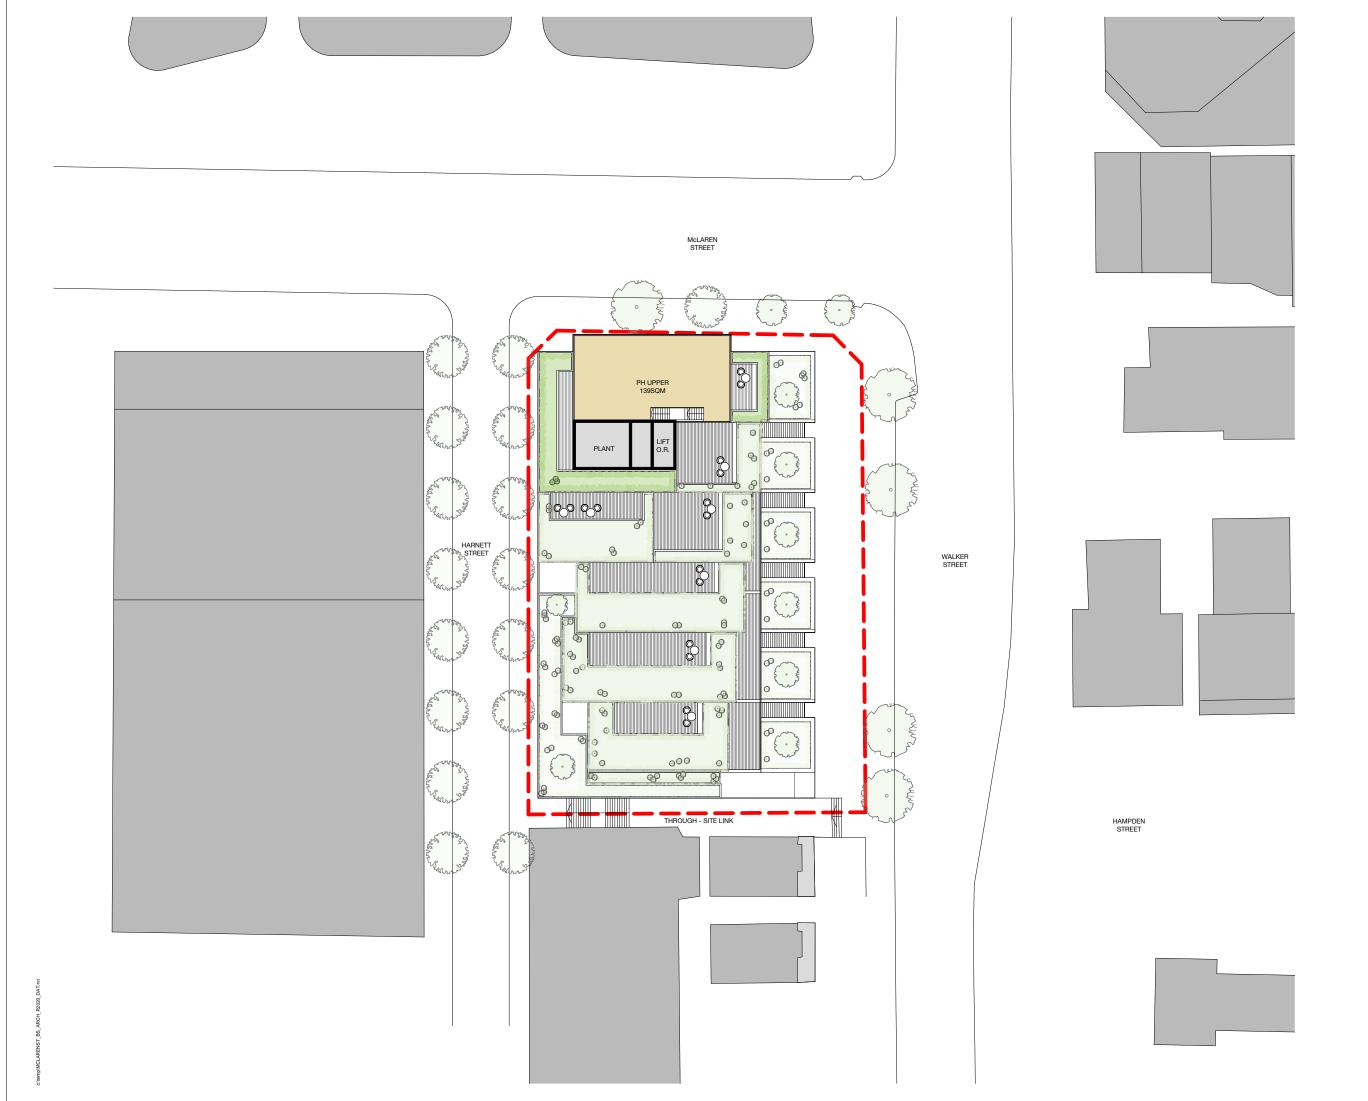S12400 45 McLaren Street

A02



Status	Planning Proposal		
Scale	1:200 @ A1		
Drawn	JC	Checked	MD
Project No.	S12400		
Plot Date	18/09/2020 2:00:18 PM		
BIM	MCLARENST_BS_ARCH_R	2020	

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Melbourne 1 Nicholson Street Melbourne VIC 3000 Australia T 03 8664 6200 F 03 8664 6300 email mel@batessmart.com.au http://www.batessmart.com.au Sydney 43 Brisbane Street Surry Hills NSW 2010 Australia T 02 8354 5100 F 02 8354 5199 email syd@batessmart.com.au http://www.batessmart.com.au

Bates Smart Pty Ltd ABN 70 004 999 400



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Rev	Date	Description	Initial	Checked
0	10.08.20	Issue for Information	MD	MD
1	21.08.20	Issue for Information	MD	MD
2	07.09.20	Issue for Information	MD	MD

S12400 45 McLaren Street

A09 Walker Street Elevation


Status	Planning Proposal		
Scale	1:200 @ A1		
Drawn	JC	Checked	MD
Project No.	S12400		
Plot Date	18/09/2020 2:00:31 PM		
BIM	MCLARENST_BS_ARCH_F	R2020	
Drawing no		Revision	

Drawing no. A09.001

Melbourne 1 Nicholson Street Melbourne VIC 3000 Australia T 03 8664 6200 F 03 8664 6300 email mel@batessmart.com.au http://www.batessmart.com.au Sydney 43 Brisbane Street Surry Hills NSW 2010 Australia T 02 8354 5100 F 02 8354 5199 email syd@batessmart.com.au http://www.batessmart.com.au

Bates Smart Pty Ltd ABN 70 004 999 400



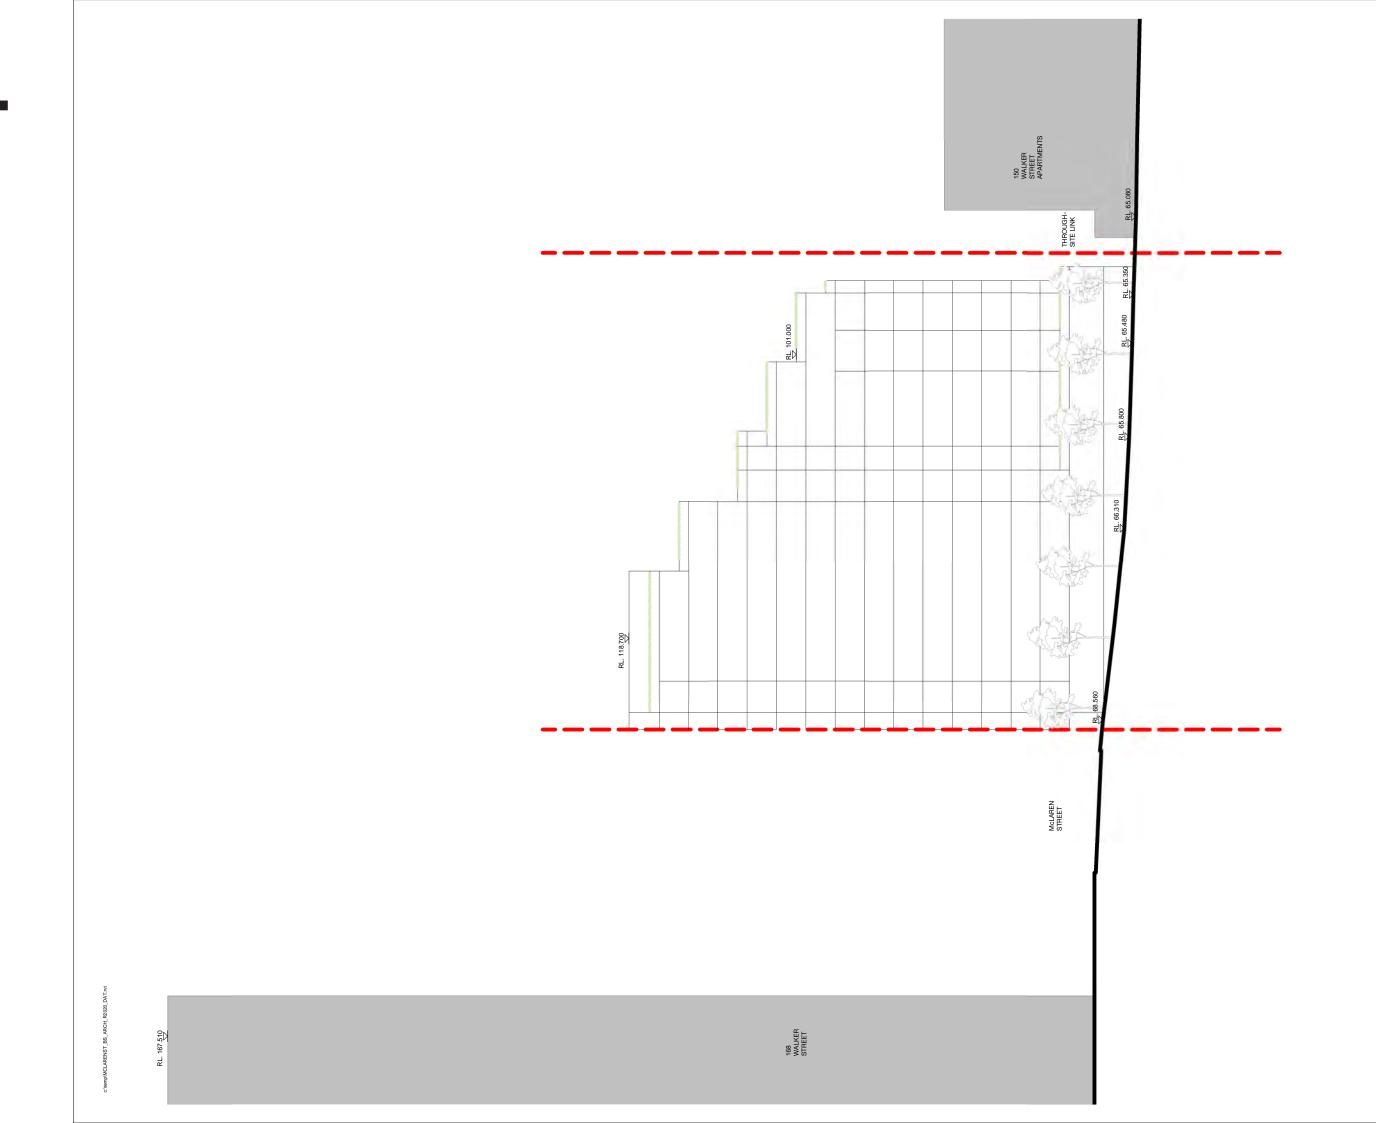

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2	07.09.20	Issue for Information	MD	MD
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Rev	Date	Description	Initial	Checke
Rev	Date	Description	Initial	Checke

S12400 45 McLaren Street

Harnett Street Elevation

Status	Planning Proposal		
Scale	1:200 @ A1		
Drawn	Author	Checked	Checker
Project No.	S12400		
Plot Date	18/09/2020 2:01:31 PM		
BIM	MCLARENST_BS_ARCH	_R2020	
Drawing no.		Revision	


A09.002

Melbourne 1 Nicholson Street Melbourne VIC 3000 Australia T 03 8664 6200 F 03 8664 6300 email mel@batessmart.com.au http://www.batessmart.com.au

Sydney 43 Brisbane Street Surry Hills NSW 2010 Australia T 02 8354 5100 F 02 8354 5199 email syd@batessmart.com.au http://www.batessmart.com.au

Bates Smart Pty Ltd ABN 70 004 999 400



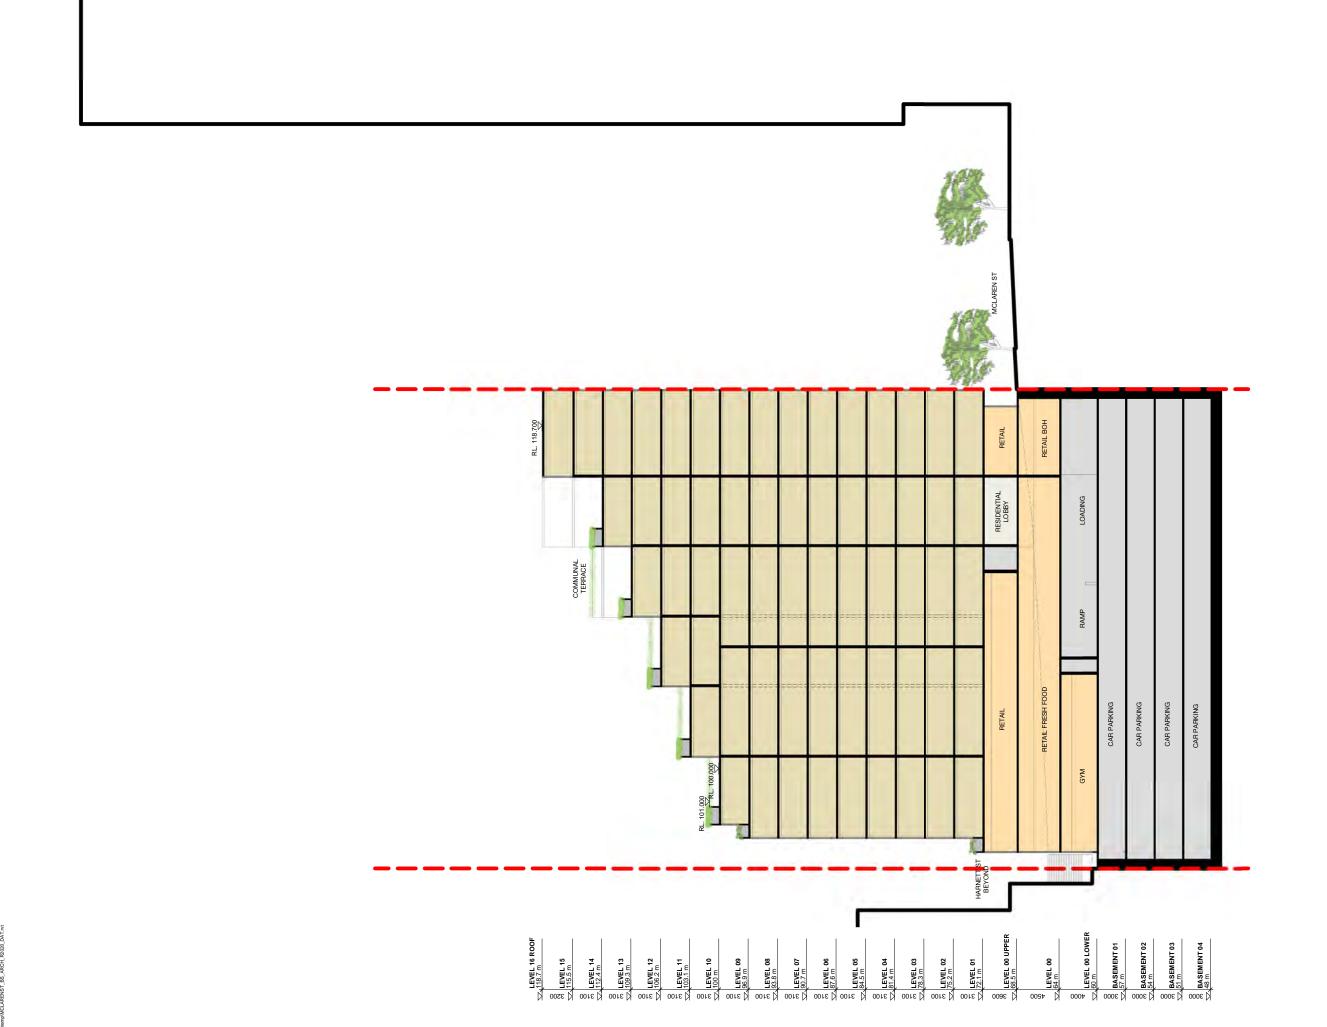


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2	07.09.20	Issue for Information	MD	MD

S12400 45 McLaren Street


A10

Status	Planning Proposal		
Scale	1:200 @ A1		
Drawn	JC	Checked	MD
Project No.	S12400		
Plot Date	18/09/2020 2:00:55 PM		
BIM	MCLARENST_BS_ARCH_F	R2020	
Drawing no.		Revision	

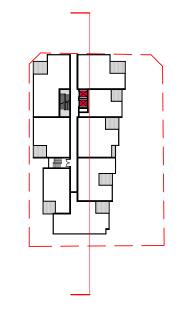A10.001

Melbourne 1 Nicholson Street Melbourne VIC 3000 Australia T 03 8664 6200 F 03 8664 6300 email mel@batesmart.com.au http://www.batessmart.com.au Sydney 43 Brisbane Street Surry Hills NSW 2010 Australia T 02 8354 5100 F 02 8354 5199 email syd@batessmart.com.au http://www.batessmart.com.au

Bates Smart Pty Ltd ABN 70 004 999 400

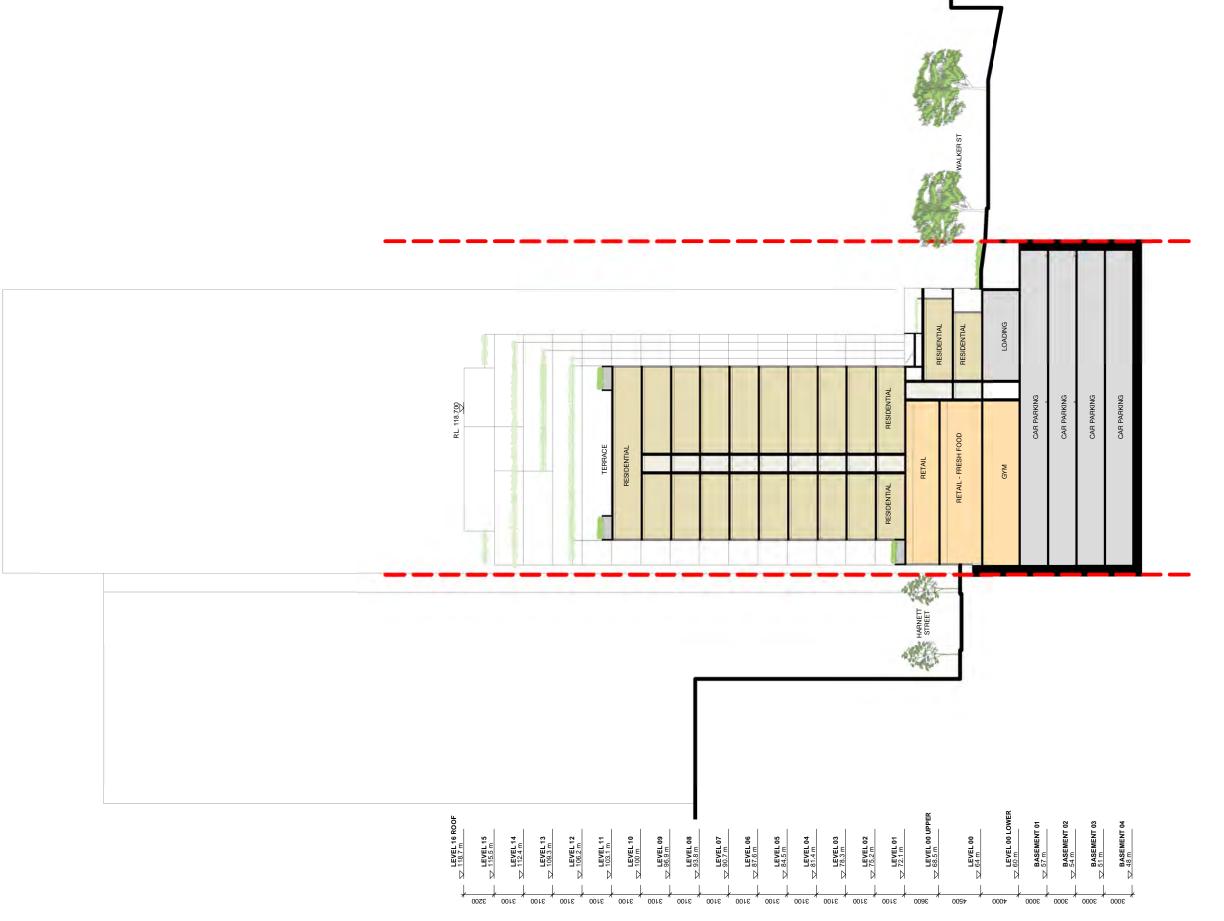


Check all dimensions and site conditions prior to commencement of any work, the purchase or ordering of any materials, fittings, plant, services or equipment and the preparation of shop drawings and or the fabrication of any components.

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Rev	Date	Description	Initial	Check
0	10.08.20	Issue for Information	MD	MD
1	21.08.20	Issue for Information	MD	MD
2	07.09.20	Issue for Information	MD	MD

S12400 45 McLaren Street

A10 Section BB

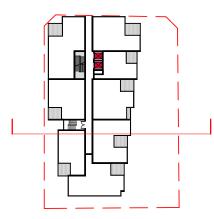Status	Planning Proposal			
Scale	1:200 @ A1			
Drawn	JC	Checked	MD	
Project No.	S12400			
Plot Date	18/09/2020 2:00:45 PM			
BIM	MCLARENST_BS_ARCH_R	12020		

A10.002

Melbourne 1 Nicholson Street Melbourne VIC 3000 Australia T 03 8664 6200 F 03 8664 6300 email mel@batessmart.com.au http://www.batessmart.com.au

Sydney 43 Brisbane Street Surry Hills NSW 2010 Australia T 02 8354 5100 F 02 8354 5199 email syd@batessmart.com.au http://www.batessmart.com.au

Bates Smart Pty Ltd ABN 70 004 999 400




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S12400 45 McLaren Street

A10 Street Section Walker

Status	Planning Proposal		
Scale	1:100 @ A1		
Drawn	JC	Checked	MD
Project No.	S12400		
Plot Date	18/09/2020 2:01:23 PM		
BIM	MCLARENST_BS_ARCH_I	R2020	
Drawing no.		Revision	

A10.101

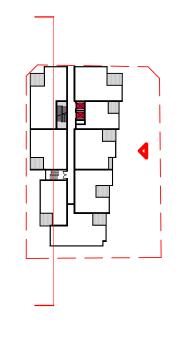Melbourne 1 Nicholson Street Melbourne VIC 3000 Australia T 03 8664 6200 F 03 8664 6300 email mel@batessmart.com.au http://www.batessmart.com.au

Sydney 43 Brisbane Street Surry Hills NSW 2010 Australia T 02 8354 5100 F 02 8354 5199 email syd@batessmart.com.au http://www.batessmart.com.au

Bates Smart Pty Ltd ABN 70 004 999 400

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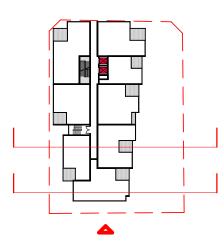


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Rev	Date	Description	Initial	Checked
0	10.08.20	Issue for Information	MD	MD
1	21.08.20	Issue for Information	MD	MD
2	27.08.20	Issue for Information	MD	MD
3	07.09.20	Issue for Information	MD	MD

S12400 45 McLaren Street

A10 Street Section East-West

Status	Planning Proposal		
Scale	1:100 @ A1		
Drawn	Author	Checked	Checker
Project No.	S12400		
Plot Date	28/09/2020 8:50:03 PM		
BIM	MCLARENST_BS_ARCH_R	R2020	
Drawing no.		Revision	

A10.103

Melbourne 1 Nicholson Street Melbourne VIC 3000 Australia T 03 8664 6200 F 03 8664 6300 email mel@batessmart.com.au http://www.batessmart.com.au

Sydney 43 Brisbane Street Surry Hills NSW 2010 Australia T 02 8354 5100 F 02 8354 5199 email syd@batessmart.com.au http://www.batessmart.com.au

Bates Smart Pty Ltd ABN 70 004 999 400

Appendix C - Site Photographs (taken 15 July 2020)






Photograph 1: Basement car park access; slab(s) in good condition (facing south west).



Photograph 2: Rear garden area; vegetation in healthy condition (facing west).



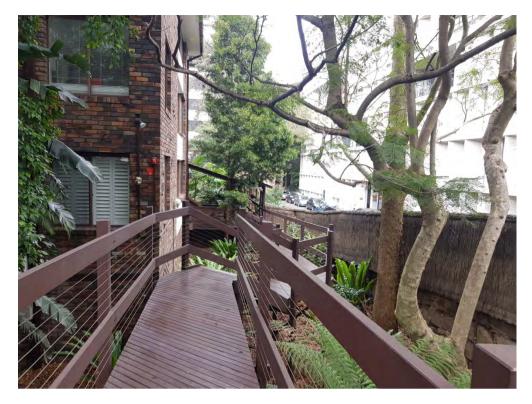

Photograph 3: Elevated timber pathway adjacent to western boundary fence (facing south).







ABN: 36 092 724 251 Ph: 02 9099 7400 (Ph: 0412 199 304)

Level 14, 135 King Street, Sydney Sydney 2000 GPO Box 4103 Sydney NSW 2001 DX 967 Sydney

Summary of Owners Report

Address: - 45 McLaren Street, North Sydney

Description: - Strata Plan No. 14598

As regards the part numbered (1) on the attached Cadastral Records Enquiry Report

Date of Acquisition and term held	Registered Proprietor(s) & Occupations where available	Reference to Title at Acquisition and sale
22.09.1922 (1922 to 1923)	Agnes Jane Newton (Widow)	Vol 1305 Fol 152
15.05.1923 (1923 to 1937)	Ada Elise Lovegrove (Spinster)	Vol 1305 Fol 152
25.05.1937 (1937 to 1946)	Ethel Mary Kate Lovegrove (Spinster) Horace Charles Lovegrove (Optician) (Transmission Application not investigated)	Vol 1305 Fol 152 Now Vol 4844 Fol's 28 & 29
01.08.1946 (1946 to 1957)	Ethel Mary Kate Lovegrove (Spinster) Selina Elizabeth Lovegrove (Widow) (Transmission Application not investigated)	Vol 4844 Fol's 28 & 29
18.12.1957 (1957 to 1958)	Ethel Mary Kate Lovegrove (Spinster) John Abbott Palmer (Company Secretary) (Section 94 Application not investigated)	Vol 4844 Fol's 28 & 29
30.05.1958 (1958 to 1958)	John Abbott Palmer (Company Secretary) Arthur Lynton Clowes (Medical Practitioner) Frank Meredith Clowes (Retired) (Transmission Application not investigated)	Vol 4844 Fol's 28 & 29 Now Vol 4844 Fol 29 & Vol 7547 Fol's 86 & 87
30.05.1958 (1958 to 1959)	John Abbott Palmer (Company Secretary) Marie Elaine Josephine Jamieson (Spinster) Frank Meredith Clowes (Retired)	Vol 4844 Fol 29 & Vol 7547 Fol's 86 & 87
24.07.1959 (1959 to 1975)	Marie Elaine Josephine Jamieson (Spinster)	Vol 4844 Fol 29 & Vol 7547 Fol's 86 & 87 Now Vol 7776 Fol 145
17.01.1975 (1975 to 1980)	Kurralta Pty Limited	Vol 7776 Fol 145

As regards the part numbered (2) on the attached Cadastral Records Enquiry Report

Date of Acquisition and term held	Registered Proprietor(s) & Occupations where available	Reference to Title at Acquisition and sale
22.09.1922 (1922 to 1930)	Agnes Jane Newton (Widow) (& her deceased estate)	Vol 1305 Fol 151
01.08.1930 (1930 to 1934)	Frank Newton (Clerk)	Vol 1305 Fol 151
06.06.1934 (1934 to 1935)	William Daniel Kennedy (Engineer) Edith Kennedy (Married Woman)	Vol 1305 Fol 151
15.11.1935 (1935 to 1939)	Robert Duncan Stewart (Retired Civil Servant)	Vol 1305 Fol 151



ABN: 36 092 724 251 Ph: 02 9099 7400 (Ph: 0412 199 304)

Level 14, 135 King Street, Sydney Sydney 2000 GPO Box 4103 Sydney NSW 2001 DX 967 Sydney

Continued as regards the part numbered (2) on the attached Cadastral Records Enquiry Report

Date of Acquisition and term held	Registered Proprietor(s) & Occupations where available	Reference to Title at Acquisition and sale
29.08.1939 (1939 to 1947)	Helen Sophia Work (Widow) (& her deceased estate)	Vol 1305 Fol 151 Now Vol 5640 Fol 2
16.04.1947 (1947 to 1947)	Paul Frederick Joseph Madden (Accountant)	Vol 5640 Fol 2
05.05.1947 (1947 to 1974)	Norbert Sale Madden (Taxi Driver) Kathleen Agnes Madden (Married Woman)	Vol 5640 Fol 2
06.12.1974 (1974 to 1977)	Norbert Sale Madden (Gardener)	Vol 5640 Fol 2
04.03.1977 (1977 to 1978)	Paul Frederick Madden (Accountant) Peter Baldock (Civil Engineer)	Vol 5640 Fol 2
10.01.1978 (1978 to 1980)	Kurralta Pty Limited	Vol 5640 Fol 2

As regards the part numbered (3) on the attached Cadastral Records Enquiry Report

Date of Acquisition and term held	Registered Proprietor(s) & Occupations where available	Reference to Title at Acquisition and sale
09.01.1905 (1905 to 1936)	Eliza Moore (Married Woman)	Vol 1305 Fol 153
02.09.1936 (1936 to 1949)	Samuel Stewart Moore (Retired Merchant) (Transmission Application not investigated)	Vol 1305 Fol 153 Now Vol 4786 Fol 242
13.09.1949 (1949 to 1974)	Doris McRae (Spinster) (Transmission Application not investigated)	Vol 4786 Fol 242
17.1.21974 (1974 to 1975)	Ian Charles Wigney (Wholesaler)	Vol 4786 Fol 242
04.02.1975 (1975 to 1980)	Kurralta Pty Limited	Vol 4786 Fol 242

As regards the part numbered (4) on the attached Cadastral Records Enquiry Report

Date of Acquisition and term held	Registered Proprietor(s) & Occupations where available	Reference to Title at Acquisition and sale
22.09.1887 (1887 to 1919)	Annie Lehmann (Married Woman)	Vol 771 Fol 49
17.12.1919 (1919 to 1973)	Annie Anne Lehmann (Spinster) (Transmission Application not investigated)	Vol 771 Fol 49 Now Vol 11055 Fol 242
14.06.1973 (1973 to 1980)	Kurralta Pty Limited	Vol 11055 Fol 242



ABN: 36 092 724 251 Ph: 02 9099 7400 (Ph: 0412 199 304)

Level 14, 135 King Street, Sydney Sydney 2000 GPO Box 4103 Sydney NSW 2001 DX 967 Sydney

Search continued as regards the Common Property Areas

Date of Acquisition and term held	Registered Proprietor(s) & Occupations where available	Reference to Title at Acquisition and sale
07.01.1980	Registration date of Strata Plan No. 14598	
07.01.1980	# The Proprietors Strata Plan No. 14598	Vol 7776 Fol 145, Vol 5640 Fol 2, Vol 4786 Fol 242 & Vol 11055 Fol 242 Now CP/SP 14598

Denotes Current Registered Proprietor

Easements: -

• 31.10.1979 (D.P. 604321) Easement to Drain Water, limited in height

Leases: -NIL

Yours Sincerely Mark Groll 21 July 2020



Cadastral Records Enquiry Report: SP 14598

Locality: NORTH SYDNEY

LGA: NORTH SYDNEY

Parish: WILLOUGHBY

County: CUMBERLAND



Report Generated 6:11:21 PM, 21 July, 2020 Copyright © Crown in right of New South Wales, 2017

This information is provided as a searching aid only. Whilst every endeavour is made to ensure that current map, plan and titling information is accurately reflected, the Registrar General cannot guarantee the information provided. For ALL ACTIVITY PRIOR TO SEPTEMBER 2002 you must refer to the RGs Charting and Reference Maps

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N

SURVEYOR'S CERTIFICATE KEVIN FRANCIS BROWN KEVIN F. BROWN & ASSOC'S ered under the Surveyors Act. 1929, hereby certify that-

any wall, the inner surface or any part of which corresponds substantially with any line shown on the accompanying floor plan as a boundary of a proposed lot, exists;

any wall, floor, ceiling or structural cubic space, by reference to which any boundary of a proposed lot shown in the accompanying floor plan is defined, exists;

any building containing proposed loss erected on the land shown on the accompanying location plan and each proposed lot shown on the accompanying floor plan are wholly within the perimeter of the pared "buildest of subparagraphs (a) and (b).

in F. Berry

SIX This is sheet 1 of my Plan in

PLAN OF LOT 1 IN D.P. 604321

Mun./Shire lun./Shire : NORTH SYDNEY Locality : NORTH/SYDNEY

Parish: WILLOUGHBY

original strata plan only.

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County: CUMBERLAND

Lengths are in metres 400 Reduction Ratio 1:

STRATA PLAN 14598

C.A.: Nº 1163 OF 12-9-1979

Purpose: STRATA PLAN

Ref. Map : NORTH SYDNEY SH 56

Last Plan: D. P. 604321

Name of, and *address for service of notices on, the body corporate *Address required on

THE REGISTERED PROPRIETORS - STRATA PLAN Nº 14598

E

"MC LAREN HOUSE"

Nº 45 MC LAREN STREET, NORTH SYDNEY

2060

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 \Box

Signatures, seals and statements of intention to create easements or restrictions as to user

KURRALTA PTYLIMITED MAX G Bowson

A ASSES WEE COMPORATION LIMITED

areunto affixed by by of the Board in the Transport of ! Secretary

Director

HARNETT △ STREET (4.815) 48205 (24.805) UNDER /(A)/ (4795) GARAGES Ţ, 70 (4.72)

(473) STOREY BRICK BUILDING MELAREN HOUSE îV Nº 45

47.39

WALKER

F.B. - FLOWER BOX

(A) - EASEMENT TO DRAIN WATER 2 WIDE (VIDE D.P. GOL321)

B - BALCONY c - COURT

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SURVEYOR'S REFERENCE: 5.4524 x P.C.2060 4

Table of mm 100 110 120 130 140 150 160


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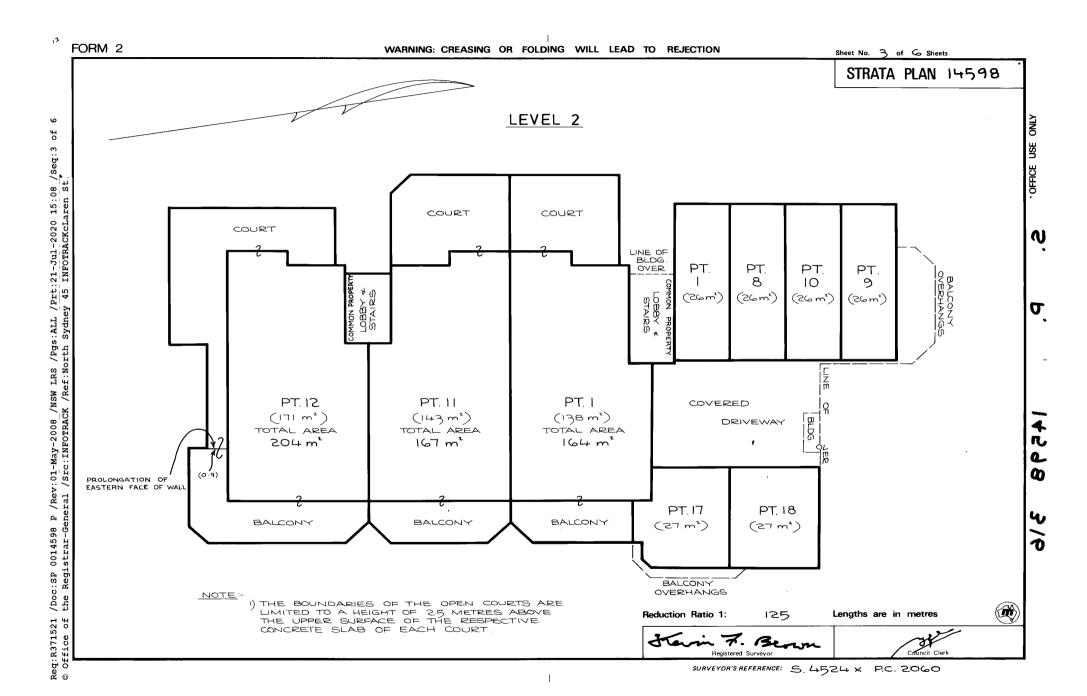
Plan Drawing only to appear in this space _


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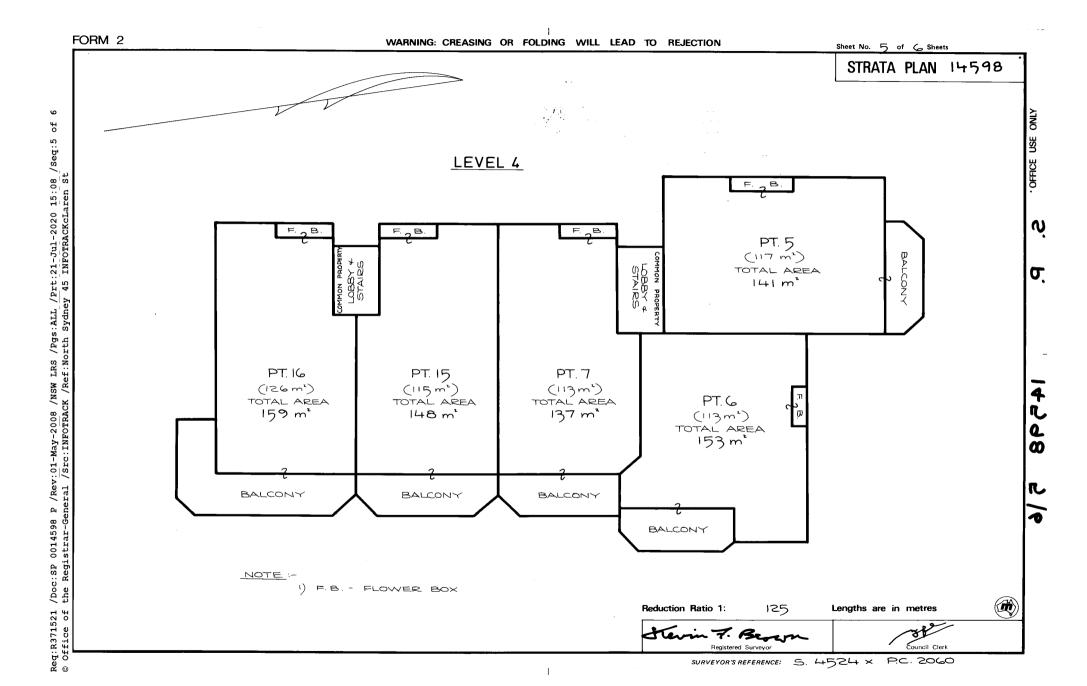
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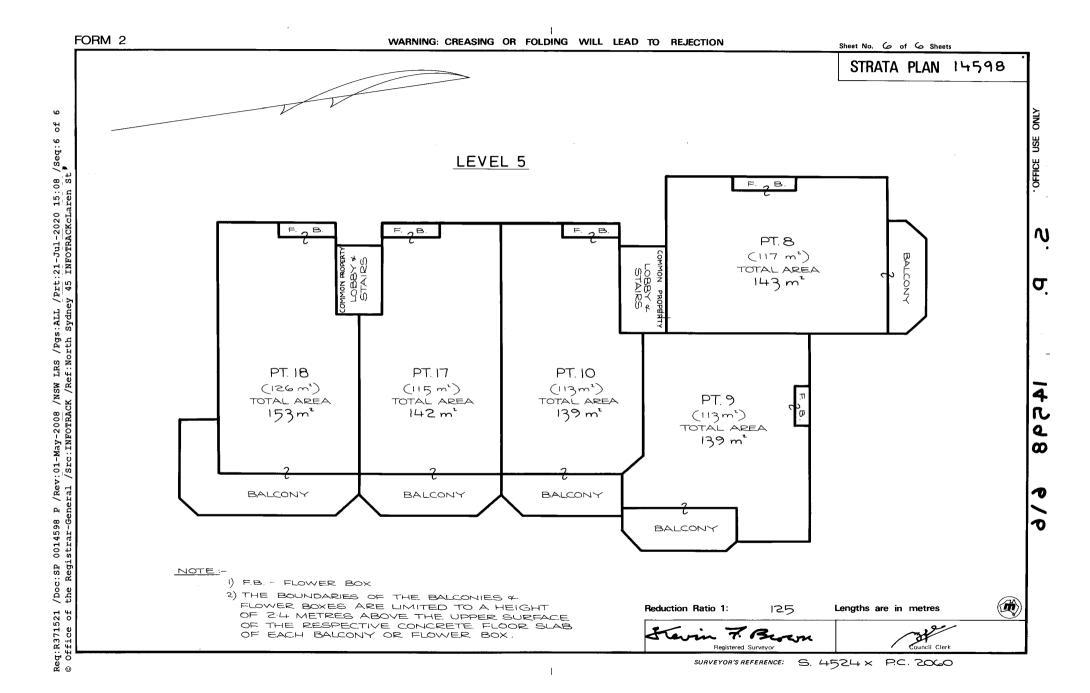
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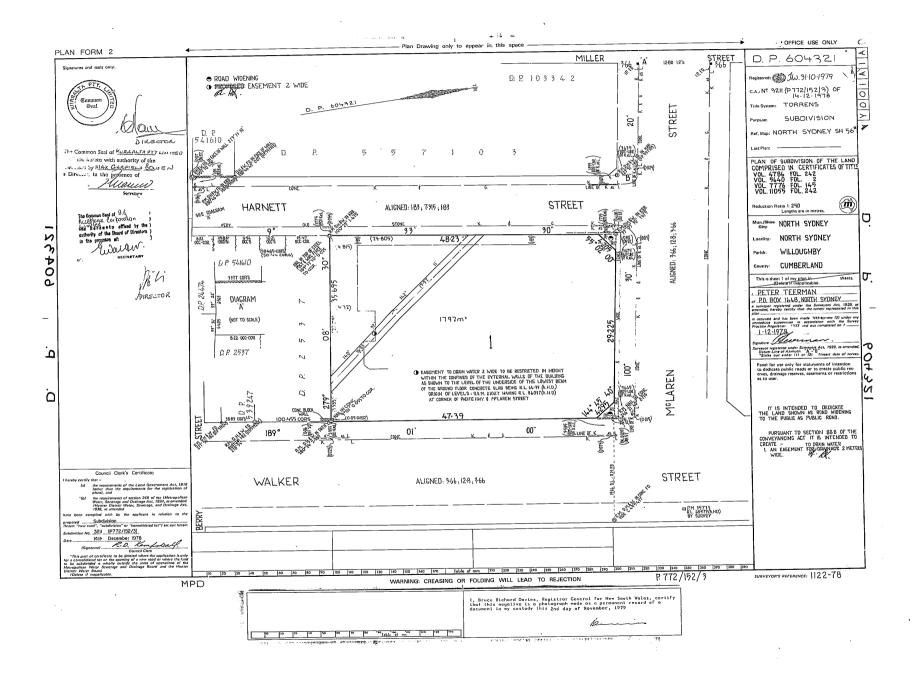








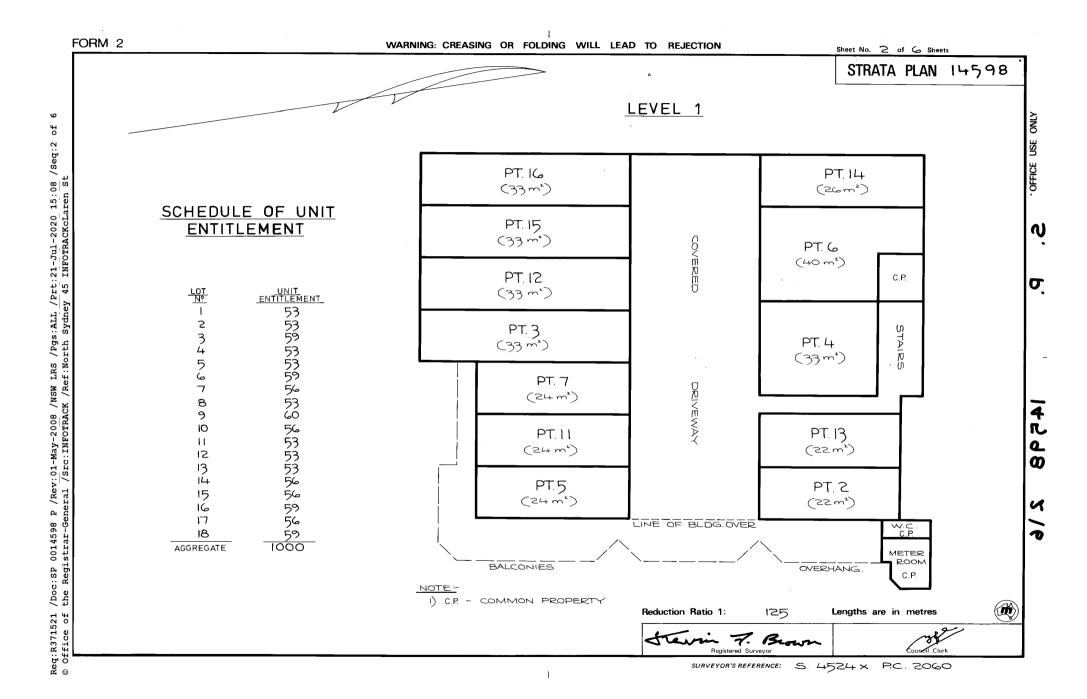

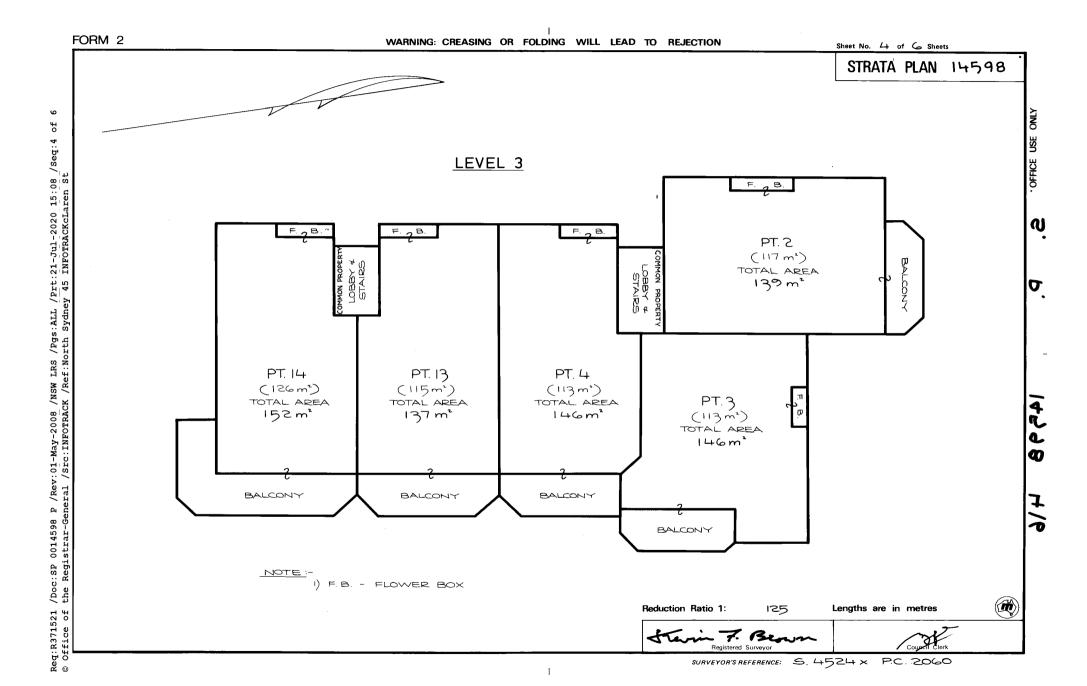

NEW SOUTH WALES

IFICATE OF TITLE

PERTY ACT, 1900, as amended.





Appln. No.3356 Prior Title Vol. 771 Fol. 49

Edition issued 26-5-1969

L403171

I certify that the person described in the First Schedule is the registered proprietor of the undermentioned estate in the land within described subject nevertheless to such exceptions encumbrances and interests as are shown in the Second Schedule.


 $_{
m Witness}$ M $extit{Hlint}$

Registrar General. PLAN SHOWING LOCATION OF LAND

AS



WARNING THIS DOCUMENT MUST NOT BE REMOVED FROM THE LAND TITLES OFFICE

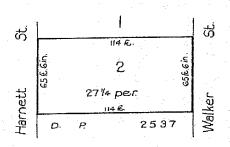

L 403171

Scale: 60 feet to one inch

ESTATE AND LAND REFERRED TO

Estate in Fee Simple in Lot 2 in plan lodged with Transfer No.100727 (Filed as F.P.908611) at St.Leonards in the Municipality of North Sydney Parish of Willoughby and County of Cumberland being parts of Allotments 8 and 9 of Section 5 granted to John Williams, the Younger on 29-10-1853 and David Charles Frederick Scott on 29-10-1853 respectively.

Spinster.

SECOND SCHEDULE

1. Reservations and conditions, if any, contained in the Crown Grants above referred to.

NOTE: ENTRIES RULED THROUGH AND AUTHENTICATED BY THE SEAL OF THE REGISTRAR GENERAL ARE CANCELLED

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Vo.

of 2

(Page

SECOND SCHEDULE (continued)								
INSTRUMENT NATURE NUMBER DATE		DATE	PARTICULARS	ENTERED	Signature of Registrar-General	CANCELLATION		
Mortguge	R89.177		To Bill Acceptance Congeniation Limited Interests created pursuant to Section 888 Conveyancing Act. 1919 by the registration of Depositor Bian. 604-321	20-2-1979 31:10-1979				6
			This deed is cancelled as to Whole New Certificates of Title have issued on 4/180 for lots in 40/2006 Plan No. 12598 as follows:					
			Lors 1 to 18 Vol. 14022 Fol. 23/talkespectively. + COMMON PROPERTY Vol. 14022 Fol. 220					
			REGISTRAR GENERAL TIS					

NOTE: ENTRIES RULED THROUGH AND AUTHENTICATED BY THE SEAL OF THE REGISTRAR-GENERAL ARE CANCELLED







(Page 1) Vol.

PERSONS ARE CAUTIONED AGAINST ALTERING OR ADOING TO THIS CERTIFICATE OR ANY NOTIFICATION HEREON

a

REAL PROPERTY ACT, 1900

TORRENS ATTALY

14022

SEE AUTO FOLIO EDITION ISSUED

1980

Crown Grants Serial 236 Pages 47 & 54

OS

Prior Titles Vol. 4786 Fol.242 Vol. 5640 Fol. 2 Vol. 7776 Fol.145 Vol.11055 Fol.242


I certify that The Proprietors - Strata Plan No. 14598 is the registered proprietor of an Estate in Fee Simple in the common property in the strata scheme relating to the Strata Plan so numbered, within the land herein described, subject nevertheless to the exceptions encumbrances and interests recorded hereon and to the reservations and conditions, if any, contained in the Crown grant.

Registrar General



PLAN SHOWING LOCATION OF LAND

LENGTHS ARE IN METRES - REDUCTION RATIO 1: 400

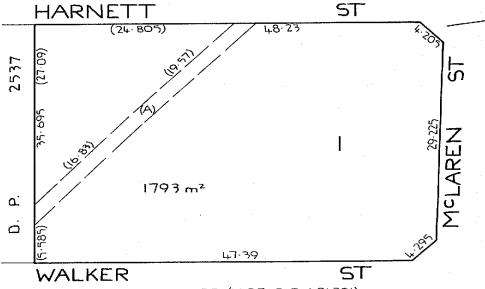

(A) EASEMENT TO DRAIN WATER 2 WIDE (VIDE D. P. 604321) ADDRESS FOR SERVICE OF NOTICES: 45 McLAREN STREET, NORTH SYDNEY.

Lot 1 in Deposited Plan 604321 at North Sydney in the Municipality of North LAND REFERRED TO Sydney Parish of Willoughby and County of Cumberland.

EXCEPTIONS ENCUMBRANCES AND INTERESTS REFERRED TO

Corpora Limited. Discharged R561494 R84177 Mortgage to Bill Easement to drain water (limited in ht) affecting the part shown so burdened the plan hereon.

SCHEDULE OF UNIT ENTITLEMENT

Aggregate Unit entitlement: 1000

Lot No.	Strata	<u>Unit</u>					
TOT NO.	Plan No.	Entitlement					
1	14598	53					
2	11	53					
3 4 5 6	11	59					
4	11	53					
5	11	53					
6	17	59					
7 8	11	56					
à	H .	53					
9	ri	60					
10	81	56					
11	H	53					
12	11	53					
13	78	53					
14	17	56					
15	17	56					
16	11	59					
17	11	56 56 59 56					
18		59					
	11						



Historical Title



NEW SOUTH WALES LAND REGISTRY SERVICES - HISTORICAL SEARCH

SEARCH DATE

21/7/2020 3:11PM

FOLIO: CP/SP14598

First Title(s): OLD SYSTEM

Prior Title(s): VOL 14022 FOL 230

Recorded	Number	Type of Instrument	C.T. Issue
29/4/1986		TITLE AUTOMATION PROJECT	LOT RECORDED FOLIO NOT CREATED
18/7/1986		CONVERTED TO COMPUTER FOLIO	FOLIO CREATED CT NOT ISSUED
2/8/2002	8708604	CHANGE OF BY-LAWS	EDITION 1
6/6/2006	AC361871	CHANGE OF BY-LAWS	EDITION 2
19/10/2006	AC679767	DEPARTMENTAL DEALING	
17/8/2017	AM654528	DEPARTMENTAL DEALING	
24/1/2018	AN64663	CONSOLIDATION/CHANGE OF BY-LAWS	EDITION 3

*** END OF SEARCH ***

 $F_{\rm ol.}230$

4022

Vol.

pages) CI of 7 (Page

NOTE: ENTRIES RULED THROUGH AND AUTHENTICATED BY THE SEAL OF THE REGISTRAR GENERAL ARE CANCELLED



NEW SOUTH WALES LAND REGISTRY SERVICES - TITLE SEARCH

FOLIO: CP/SP14598

SEARCH DATE	TIME	EDITION NO	DATE
21/7/2020	3:11 PM	3	24/1/2018

LAND

_ _ _

THE COMMON PROPERTY IN THE STRATA SCHEME BASED ON STRATA PLAN 14598 WITHIN THE PARCEL SHOWN IN THE TITLE DIAGRAM

AT NORTH SYDNEY
LOCAL GOVERNMENT AREA NORTH SYDNEY
PARISH OF WILLOUGHBY COUNTY OF CUMBERLAND
TITLE DIAGRAM SHEET 1 SP14598

FIRST SCHEDULE

THE OWNERS - STRATA PLAN NO. 14598
ADDRESS FOR SERVICE OF DOCUMENTS:
45 MCLAREN STREET
NORTH SYDNEY 2060

SECOND SCHEDULE (4 NOTIFICATIONS)

- 1 RESERVATIONS AND CONDITIONS IN THE CROWN GRANT(S)
- 2 DP604321 EASEMENT TO DRAIN WATER (LIMITED IN HEIGHT)
 AFFECTING THE SITE DESIGNATED (A) IN THE TITLE DIAGRAM
- 3 AN64663 CONSOLIDATION OF REGISTERED BY-LAWS
- 4 AN64663 INITIAL PERIOD EXPIRED

SCHEDULE OF UNIT ENTITLEMENT (AGGREGATE: 1000)

STRATA	PLAN	14598									
LOT	ENT		LOT		ENT	LOT		ENT	LOT		ENT
1 -	53		2	-	53	3	_	59	4	-	53
5 -	53		6	-	59	7	_	56	8	_	53
9 –	60		10	_	56	11	_	53	12	-	53
13 -	53		14	_	56	15	_	56	16	-	59
17 -	56		18	_	59						

NOTATIONS

UNREGISTERED DEALINGS: NIL

*** END OF SEARCH ***

North Sydney 45 McLaren St

PRINTED ON 21/7/2020

^{*} Any entries preceded by an asterisk do not appear on the current edition of the Certificate of Title. Warning: the information appearing under notations has not been formally recorded in the Register. InfoTrack an approved NSW Information Broker hereby certifies that the information contained in this document has been provided electronically by the Registrar General in accordance with Section 96B(2) of the Real Property Act 1900.